

4 FIRST FLOOR EXISTING CONDITIONS PLAN
D100 SCALE: 1" = 10'-0"

DOOR SCHEDULE				
MARK	Level	PANEL		HARDWARE SET
		WIDTH	HEIGHT	
DOOR 5	FIRST FLOOR	5' - 11"	7' - 5"	4
DOOR 4	FIRST FLOOR	5' - 3"	7' - 2 1/2"	2
DOOR 2	FIRST FLOOR	5' - 3"	7' - 1"	2
DOOR 1	FIRST FLOOR	6' - 1"	7' - 3"	1
DOOR 7	FIRST FLOOR	6' - 0"	7' - 0"	6
DOOR 8	FIRST FLOOR	3' - 0"	7' - 0"	5
DOOR 6	FIRST FLOOR	3' - 0"	7' - 0"	5
DOOR 3	FIRST FLOOR	5' - 3"	7' - 11 1/2"	3

NOTE:
THE CONTRACTOR MUST VERIFY ALL
DIMENSIONS IN THE FIELD PRIOR TO
ORDERING AND INSTALLATION



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ARCHITECT SEAL MUST BE IN RED INK
OWNER

Vision Academy Charter
School

ONE CALL #:



SITE SAFETY

It is the responsibility of the general contractor and/or the contractor listed as the licensed entity on the building permit per the municipality to ensure all site safety requirements are in place and followed, prior to, during, and after the commencement of the construction process until they are 100% complete and have received a building certificate of occupancy by governing agencies. They are also responsible for any unsafe conditions caused by or related to their sub-contractors' work. Plato Marinakos, Architect LLC, and their professional consultants (associated with these documents) are not responsible for means and methods of construction, and/or site safety; including, but not limited to, osha construction safety requirements, standard construction, job site safety, job site safety training of workers, safe work site organization, safety direction and/or safety engineering of required safety elements. It is the sole responsibility of the licensed contractor to ensure that all site safety measures are in accordance with the governing authorities. Please refer to OSHA website (www.osha.gov) for additional training and information requirements for site safety compliance.

REV	DATE	DESCRIPTION

APPROVAL STAMP

716 EMERSON AVE -
SCHOOL
lansdowne, PA.

EXISTING CONDITIONS

Project number	N/A
Date	10/04/2021
Drawn by	Author
Checked by	Checker

D100

Scale As indicated



1 DOOR 1
D100 N.T.S.



2 DOOR 2
D100 N.T.S.



3 DOOR 3
D100 N.T.S.



5 DOOR 4
D100 N.T.S.



6 DOOR 5
D100 N.T.S.



7 DOOR 6
D100 N.T.S.




8 DOOR 7
D100 N.T.S.




9 DOOR 8
D100 N.T.S.

- 1.DOR HUNG TO THE FRAME WITH HINGES
- 2.SECURITY LOCKSET
- 3.THRESHOLD NEEDED
- 4.SEALED AND PROTECTED DOR (1HR RATED)
- 5.ELECTRIFIED DOR
- 6.DOR CLOSER
- 7.DOR MUST BE SEALED

SPECIFIC CONSIDERATIONS
HEAVY FREQUENCY OF USE
2. EXPOSED TO WEATHER/CLIMATE
(ONLY FRONT DOOR)
3. MATERIAL: TEMPERED GLASS AND
ALUMINIUM

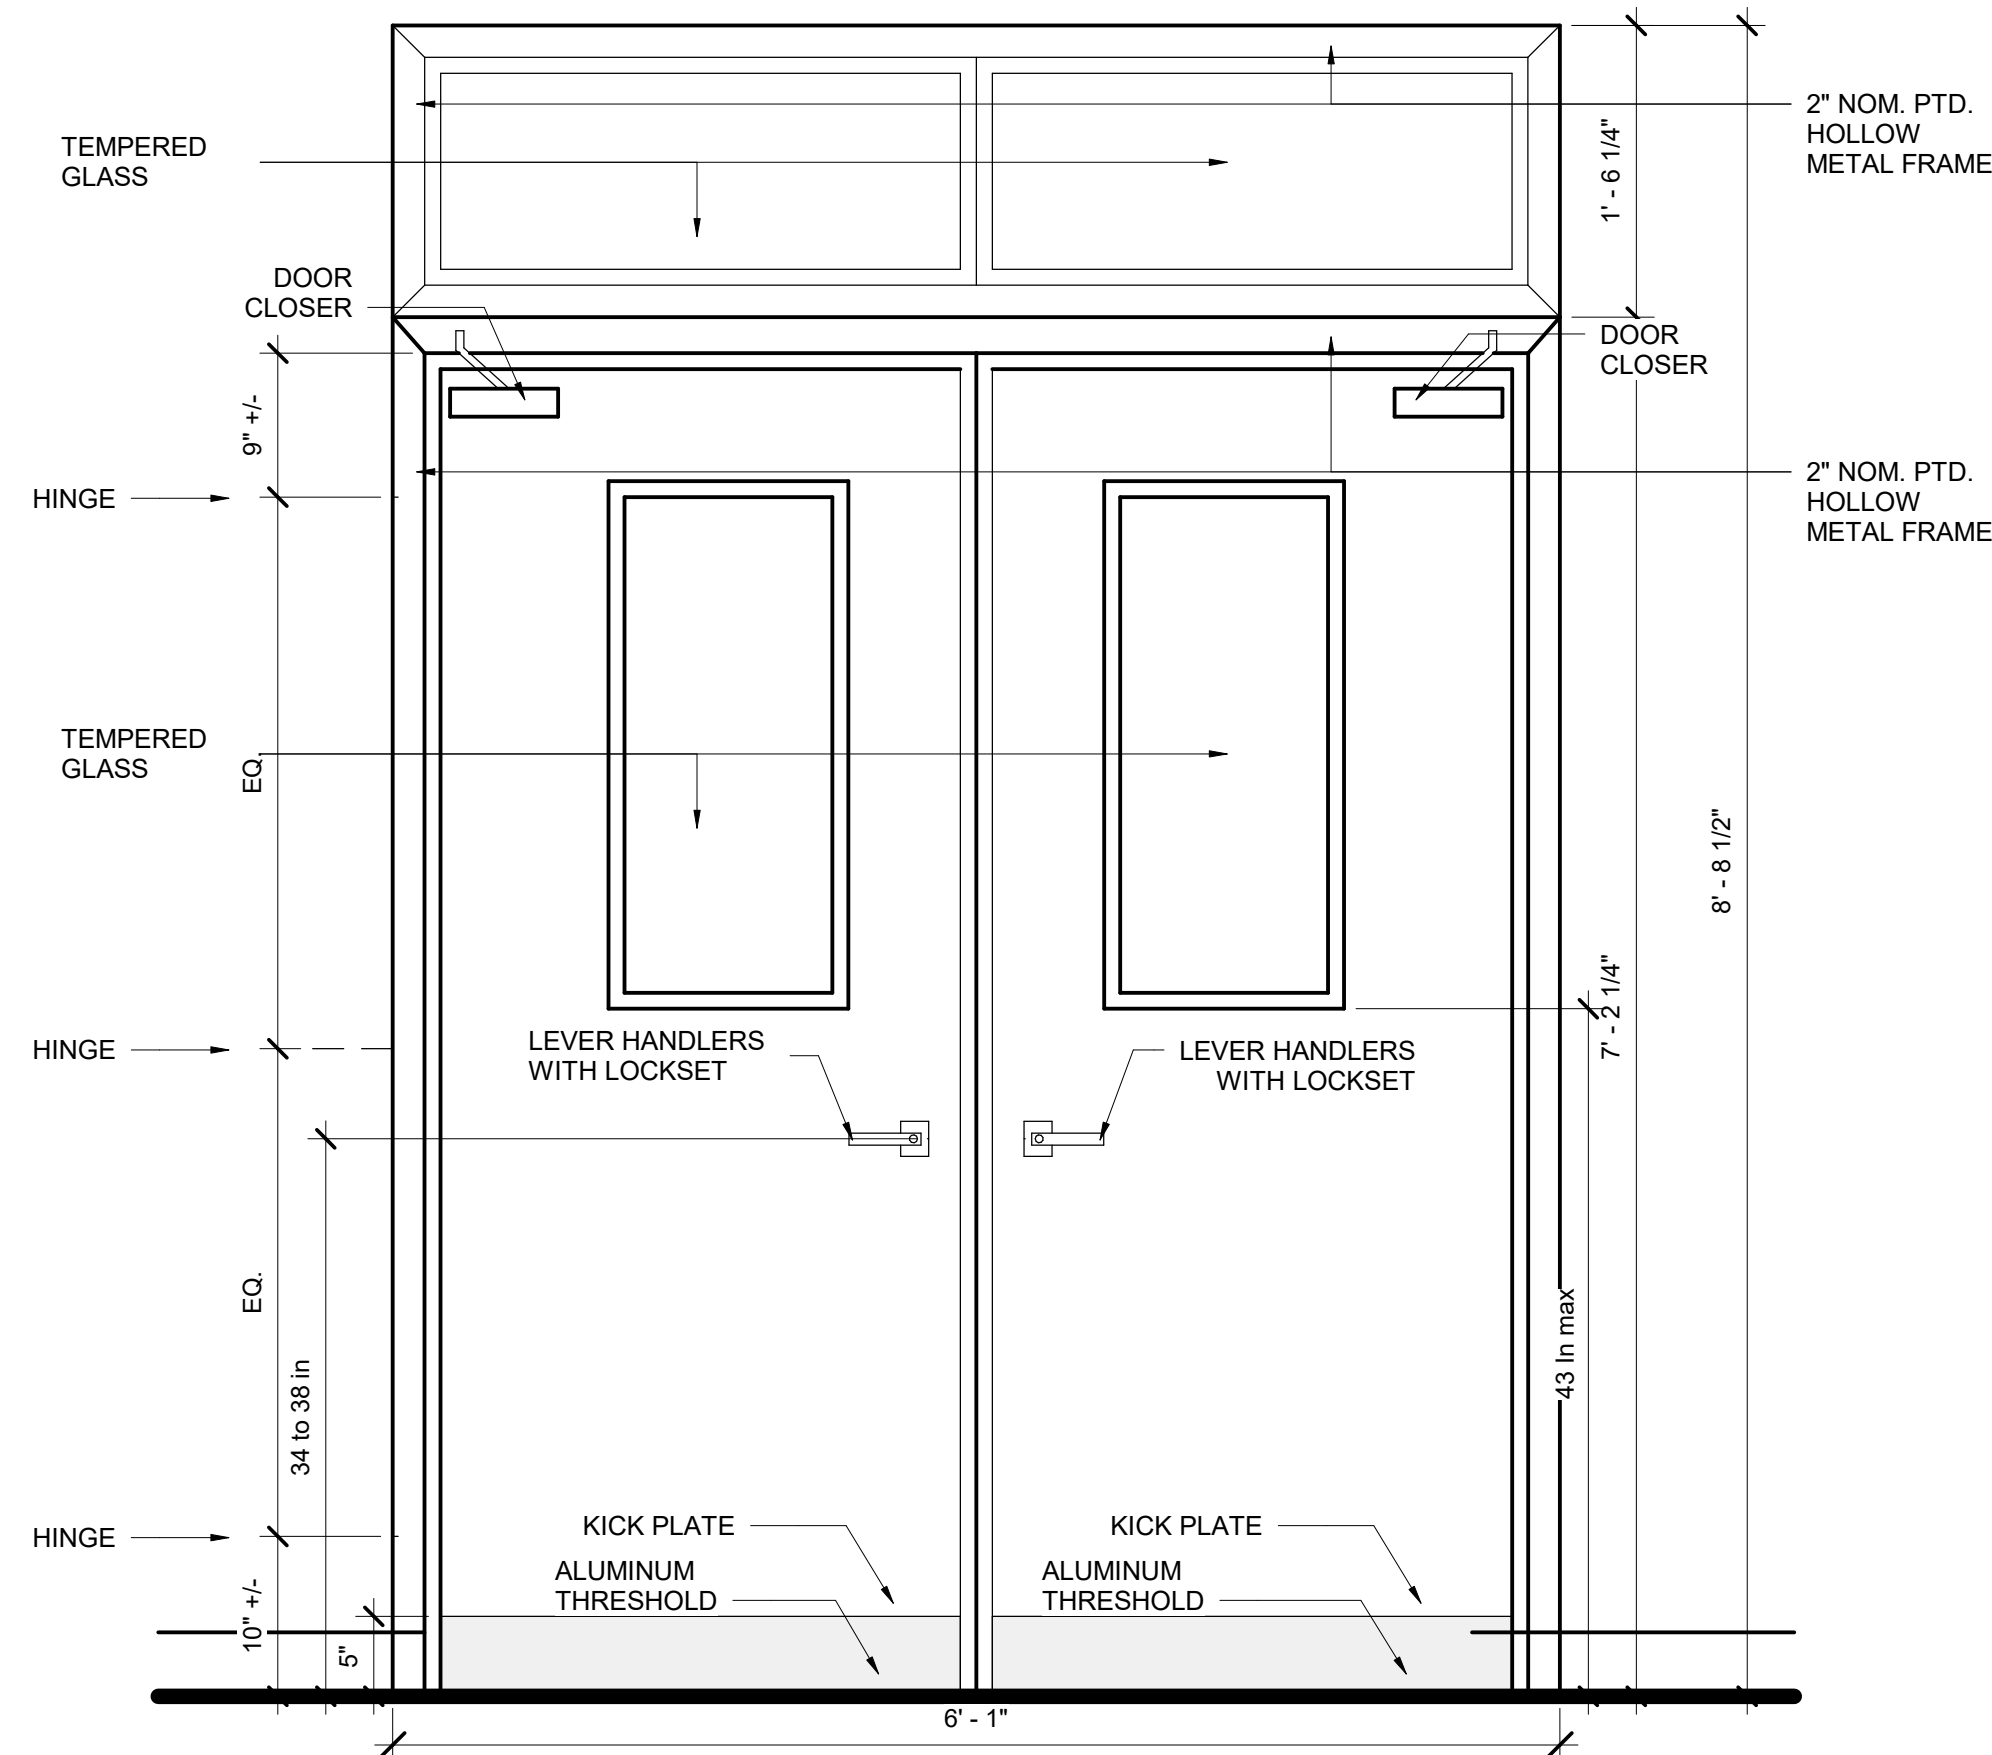

OUTSIDE THE BUILDING

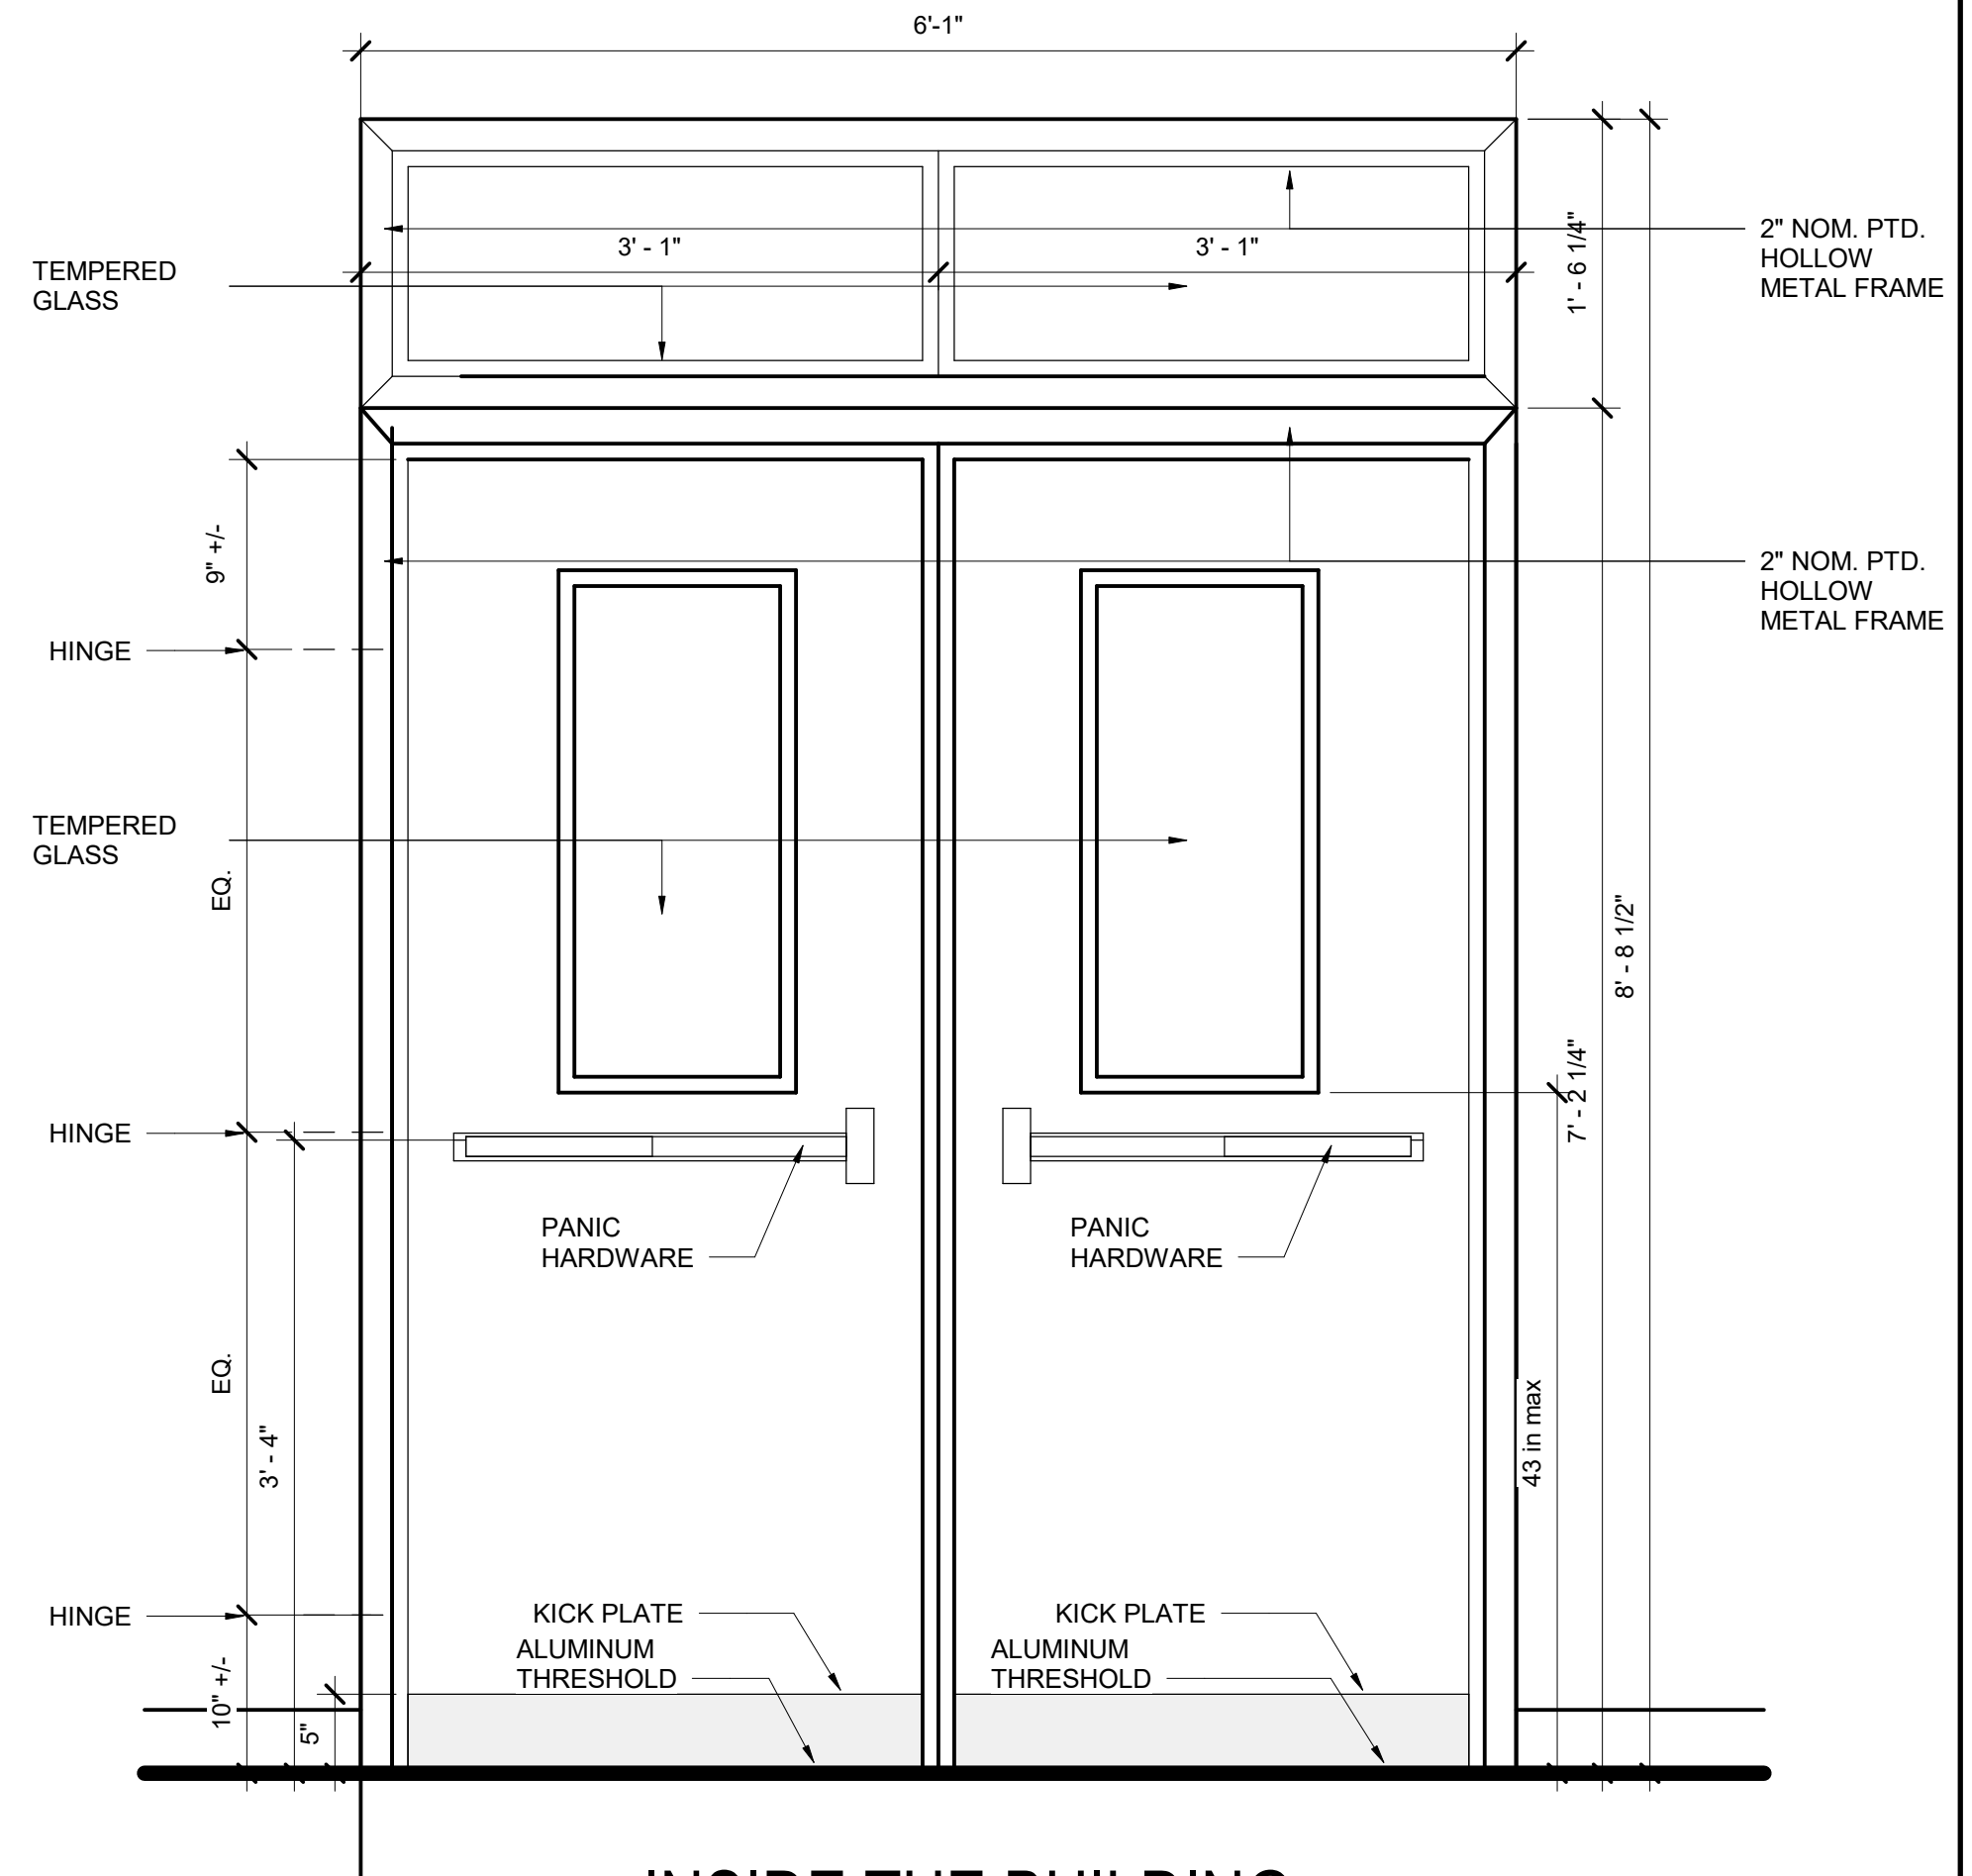


INSIDE THE BUILDING

GENERAL


- 1.DOOR HUNG TO THE FRAME WITH HINGES
- 2.SECURITY LOCKSET
- 3.THRESHOLD NEEDED
- 4.SEALED AND PROTECTED DOOR (1HR RATED)
- 5.ELECTRIFIED DOOR
- 6.DOOR CLOSER
- 7.DOOR MUST BE SEALED

SPECIFIC CONSIDERATIONS

1. HEAVY FREQUENCY OF USE
2. EXPOSED TO WEATHER/CLIMATE (ONLY FRONT DOOR)
3. MATERIAL: TEMPERED GLASS AND ALUMINIUM

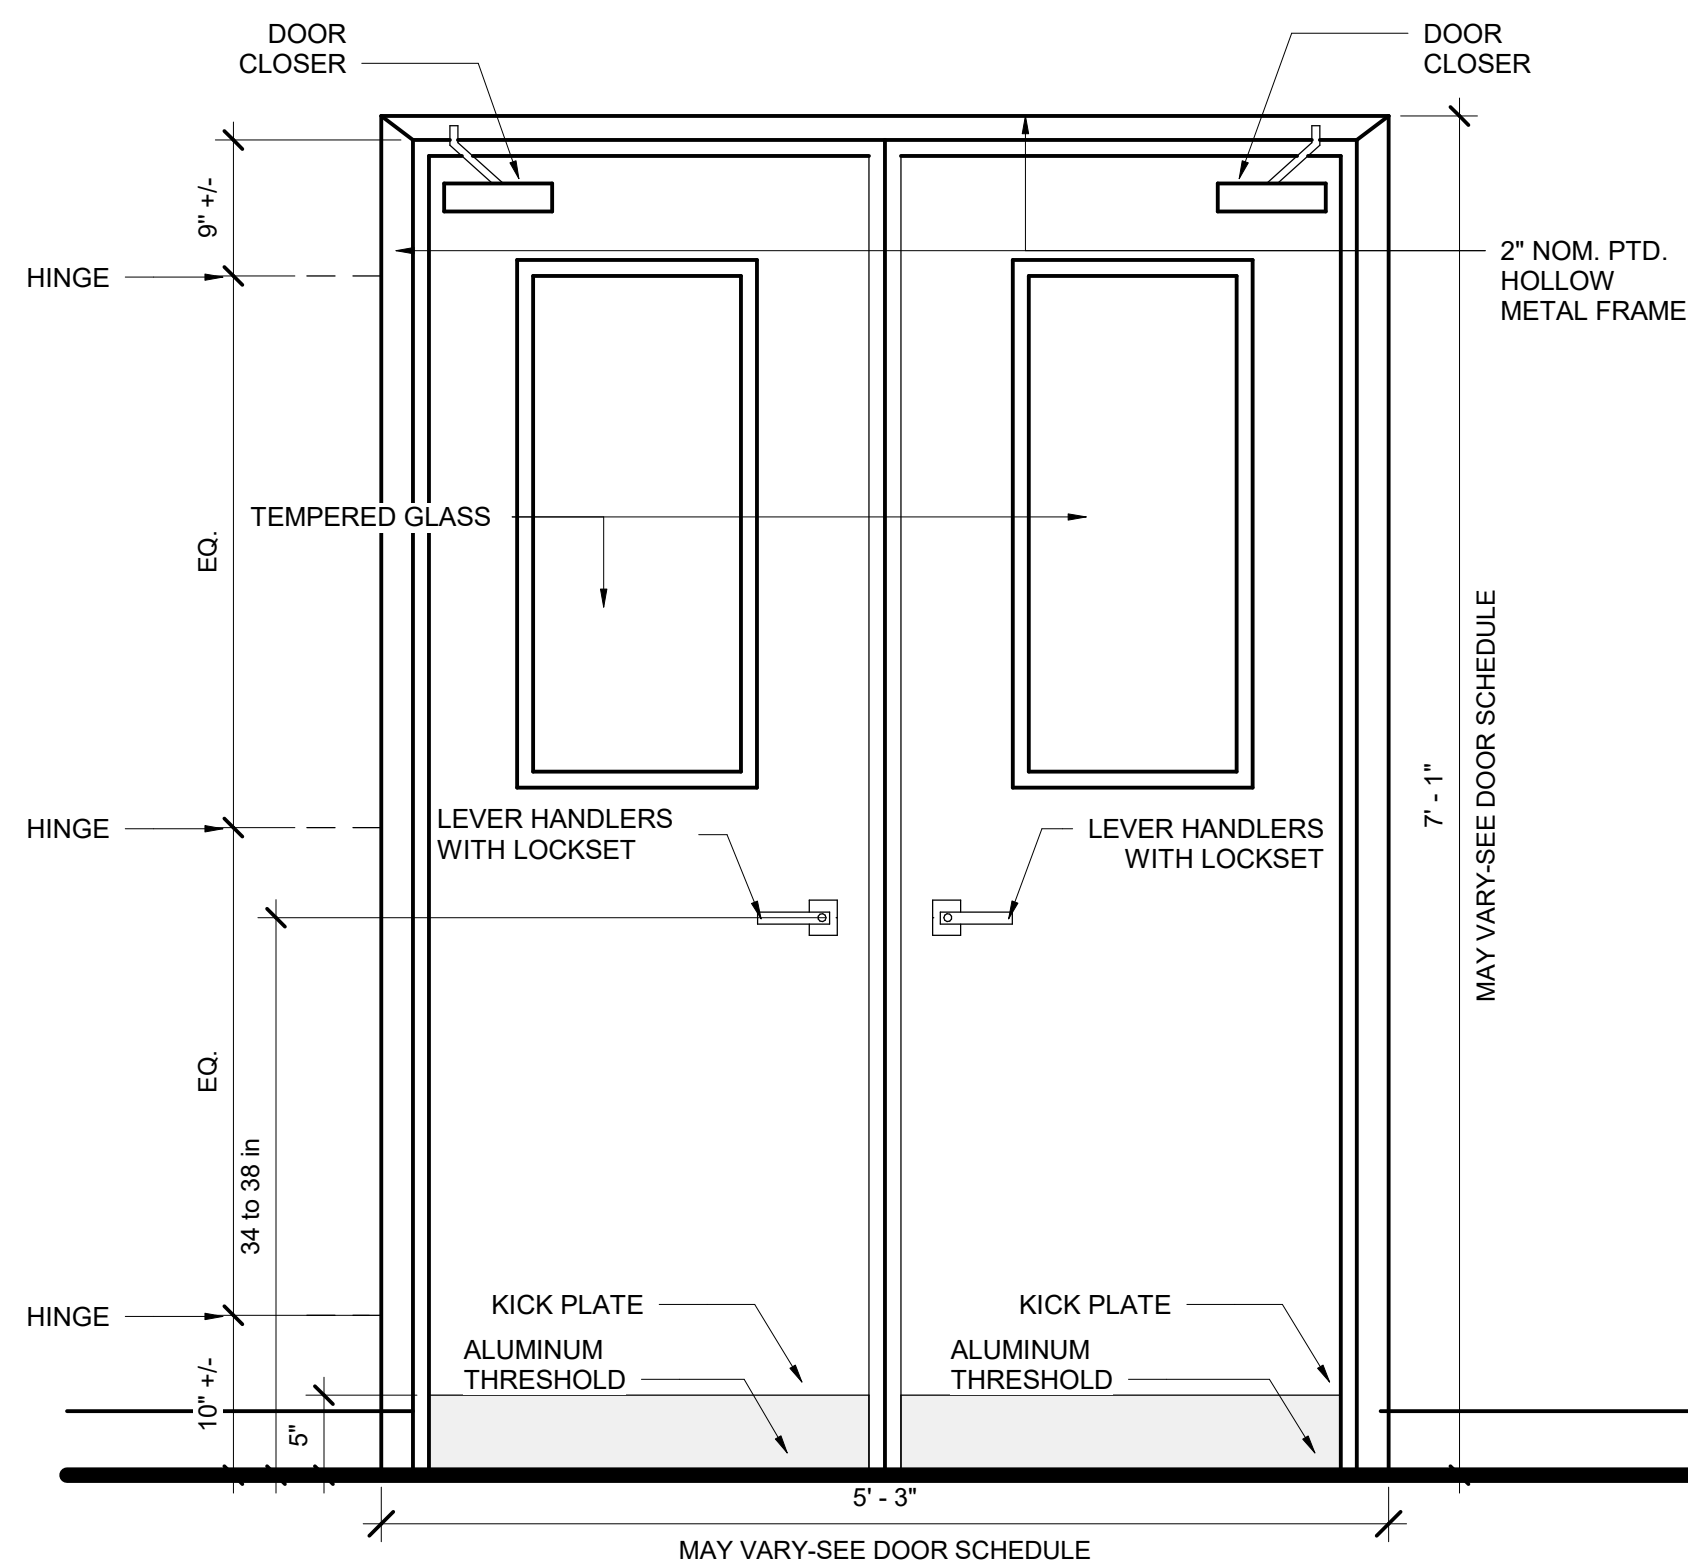

OUTSIDE THE BUILDING

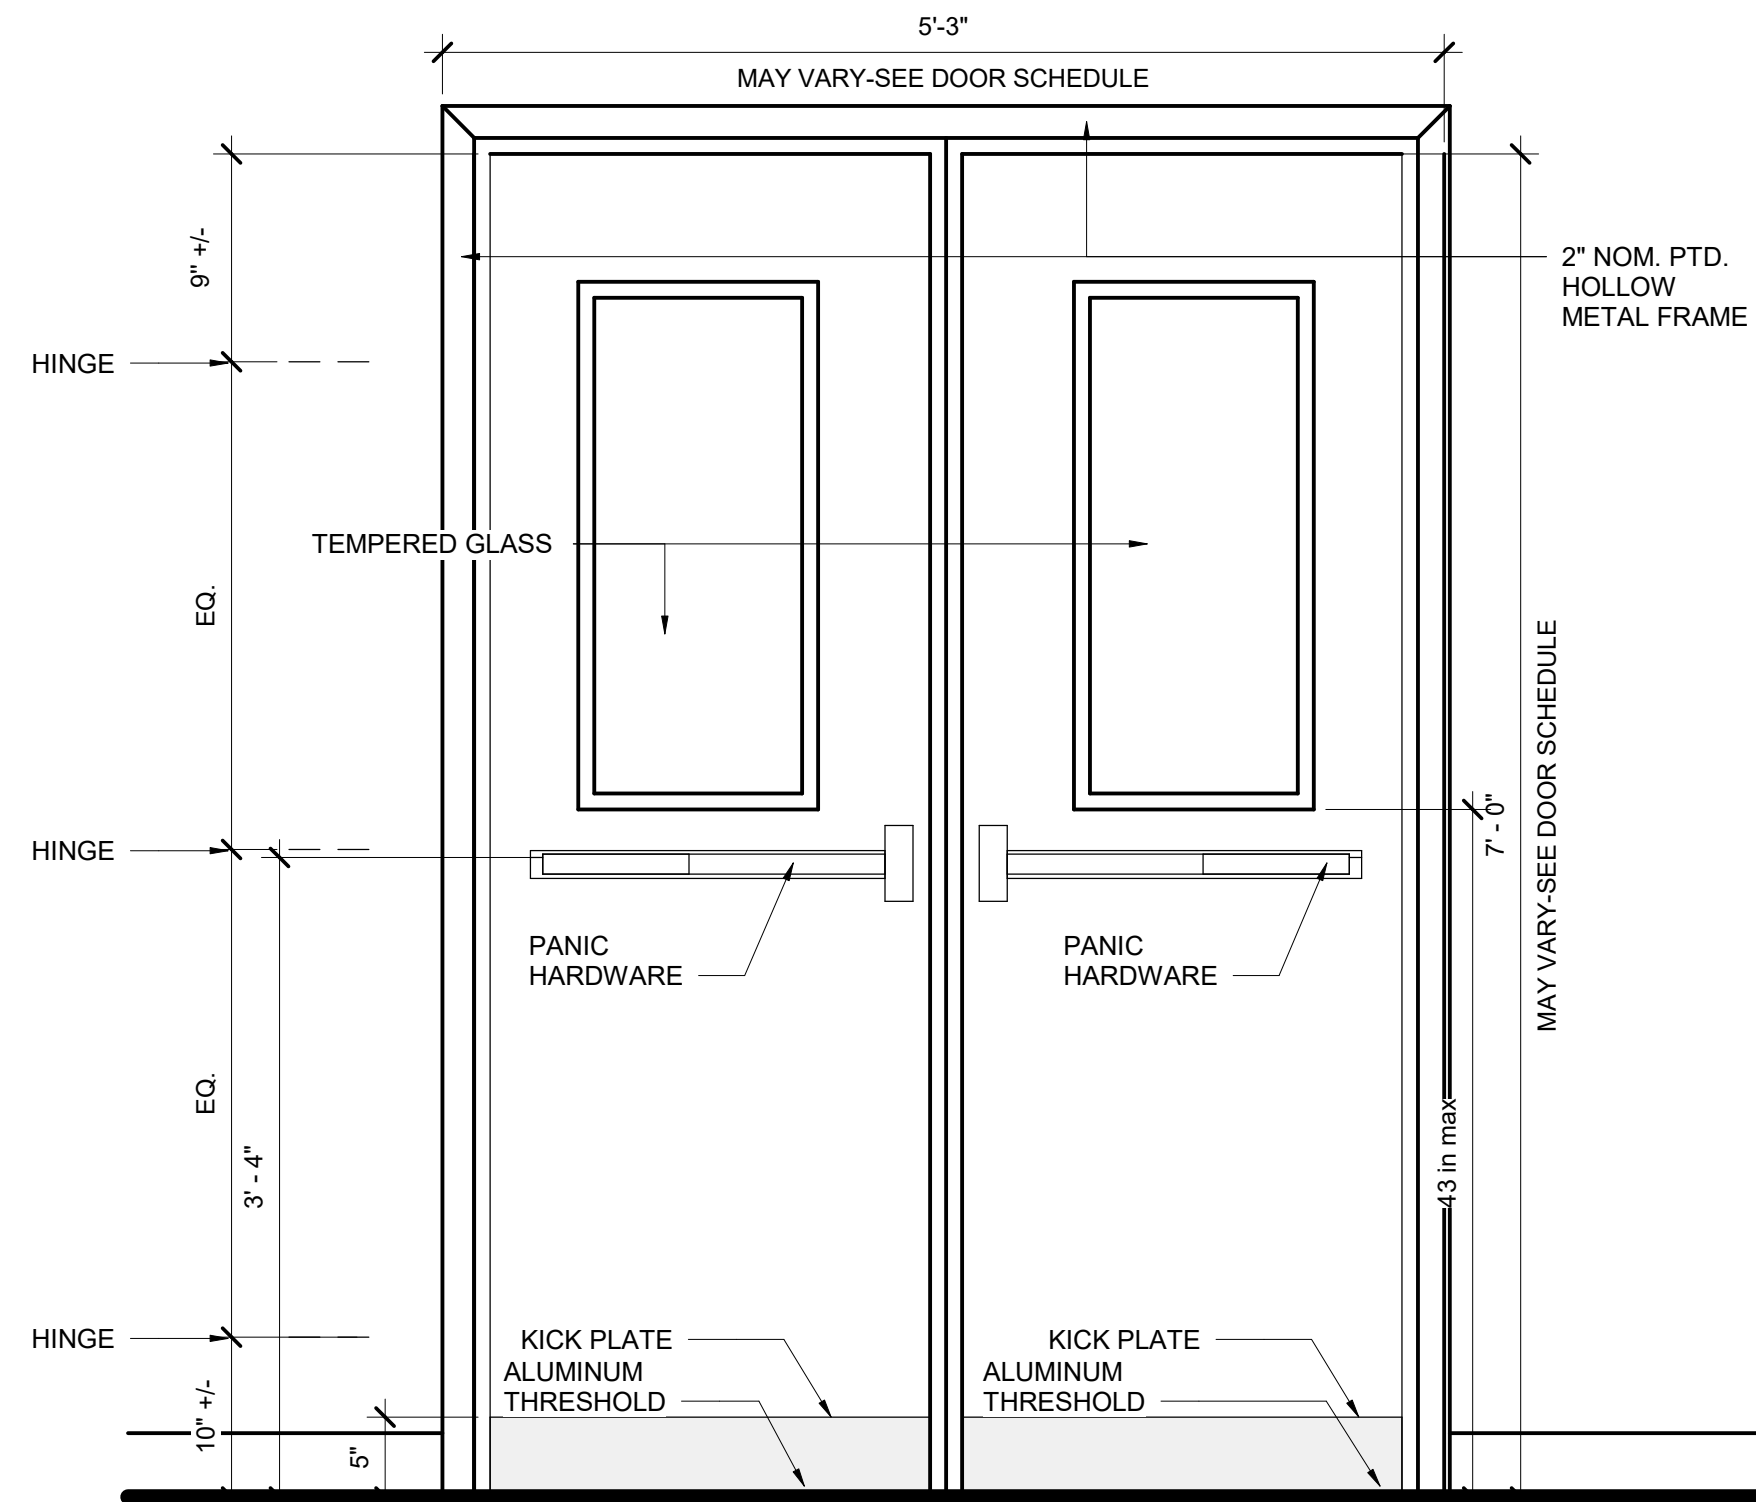

INSIDE THE BUILDING

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SITE SAFETY

is the responsibility of the general contractor and/or the contractor listed as the licensed entity on the building permit per the municipality to ensure all site safety requirements are in place and followed, prior to, during, and after commencement of the construction process until they are 100% complete. We have received a building certificate of occupancy by governing agency and have been issued a building permit by the municipality. We intend to follow their sub contractors' work. Plata Marimaks, Architect LLC, and their professional consultants (associated with these documents) are not responsible for means and methods of construction, and/or site safety; including, but not limited to, job site construction safety requirements, standard construction, job site safety, job site safety training of workers, safe work site organization, safety direction and/or safety engineering of required safety equipment and/or safety measures. We intend to follow the municipality's all site safety measures are in accordance with the governing authorities. Please refer to OSHA website (www.osha.gov) for additional training and information requirements for site safety compliance.

REV	DATE	DESCRIPTION

APPROVAL STAMP

716 EMERSON AVE -
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DOOR HARDWARE TYPES

Project number	N/A
Date	10/04/2021
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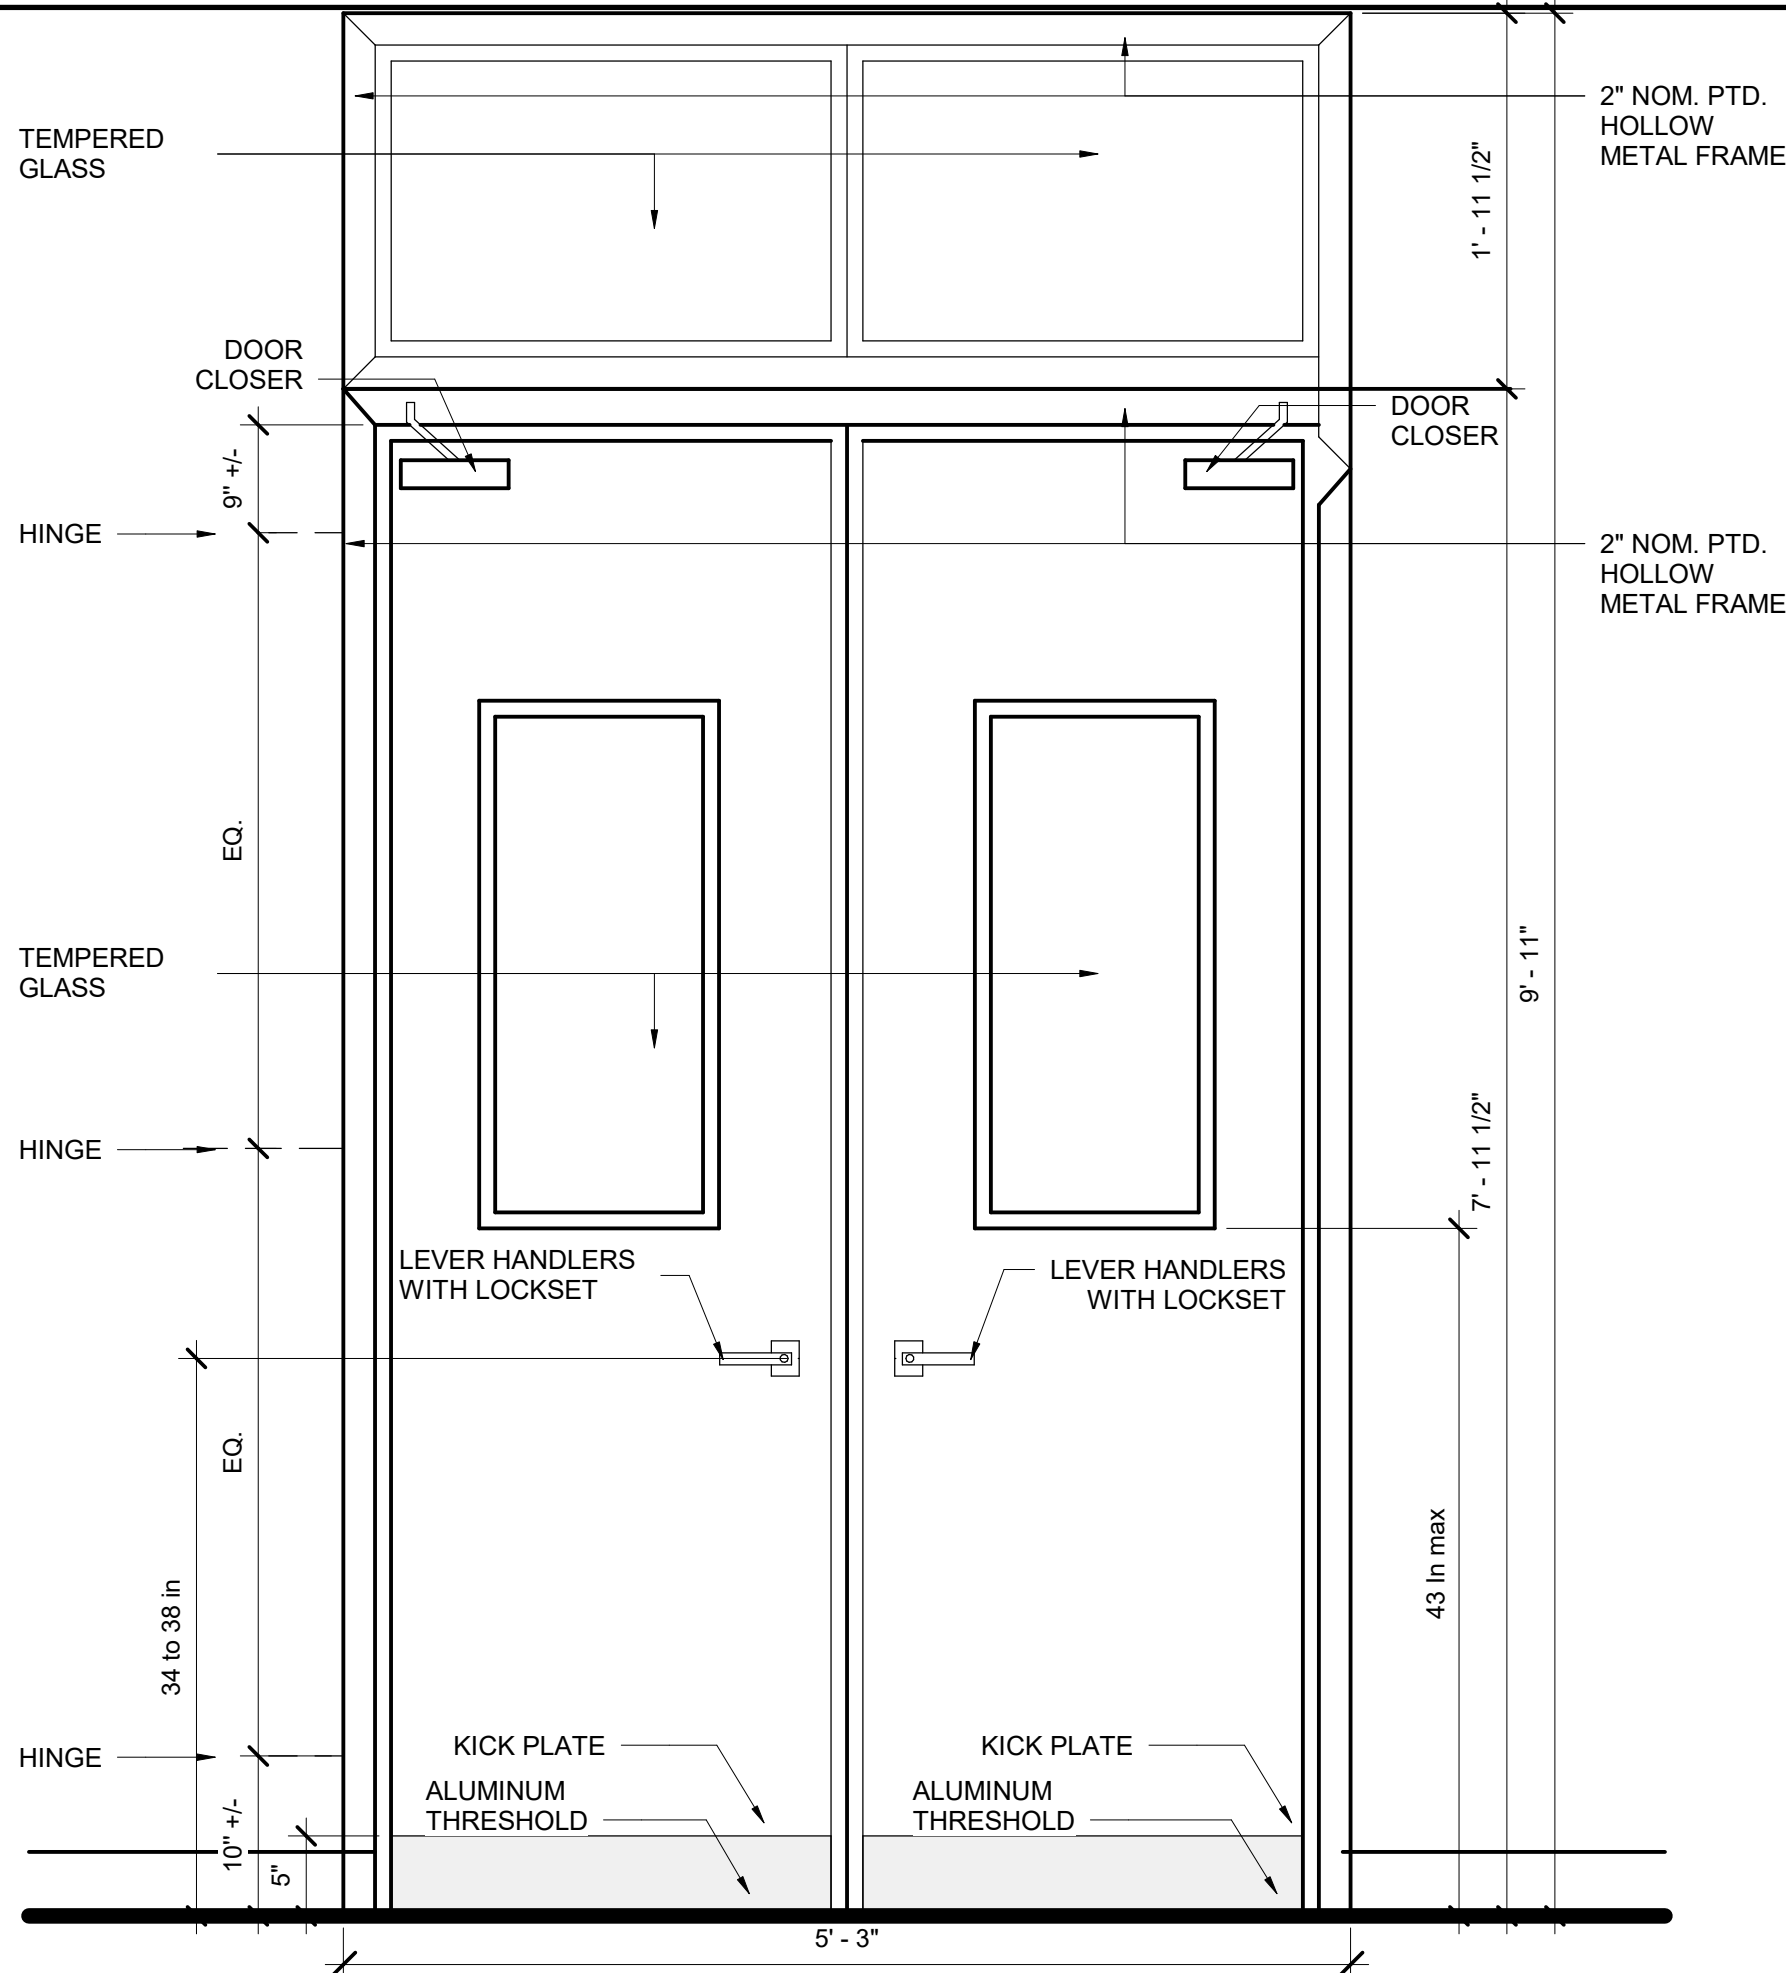
D101

Scale 1" = 1'-0"


DOOR HARDWARE SET 3

- GENERAL
- 1.DOOR HUNG TO THE FRAME WITH HINGES
 - 2.SECURITY LOCKSET
 - 3.THRESHOLD NEEDED
 - 4.SEALED AND PROTECTED DOOR (1HR RATED)
 - 5.ELECTRIFIED DOOR
 - 6.DOOR CLOSER
 - 7.DOOR MUST BE SEALED

- SPECIFIC CONSIDERATIONS
- 1. HEAVY FREQUENCY OF USE
 - 2. EXPOSED TO WEATHER/CLIMATE (ONLY FRONT DOOR)
 - 3. MATERIAL: TEMPERED GLASS AND ALUMINIUM



OUTSIDE THE BUILDING

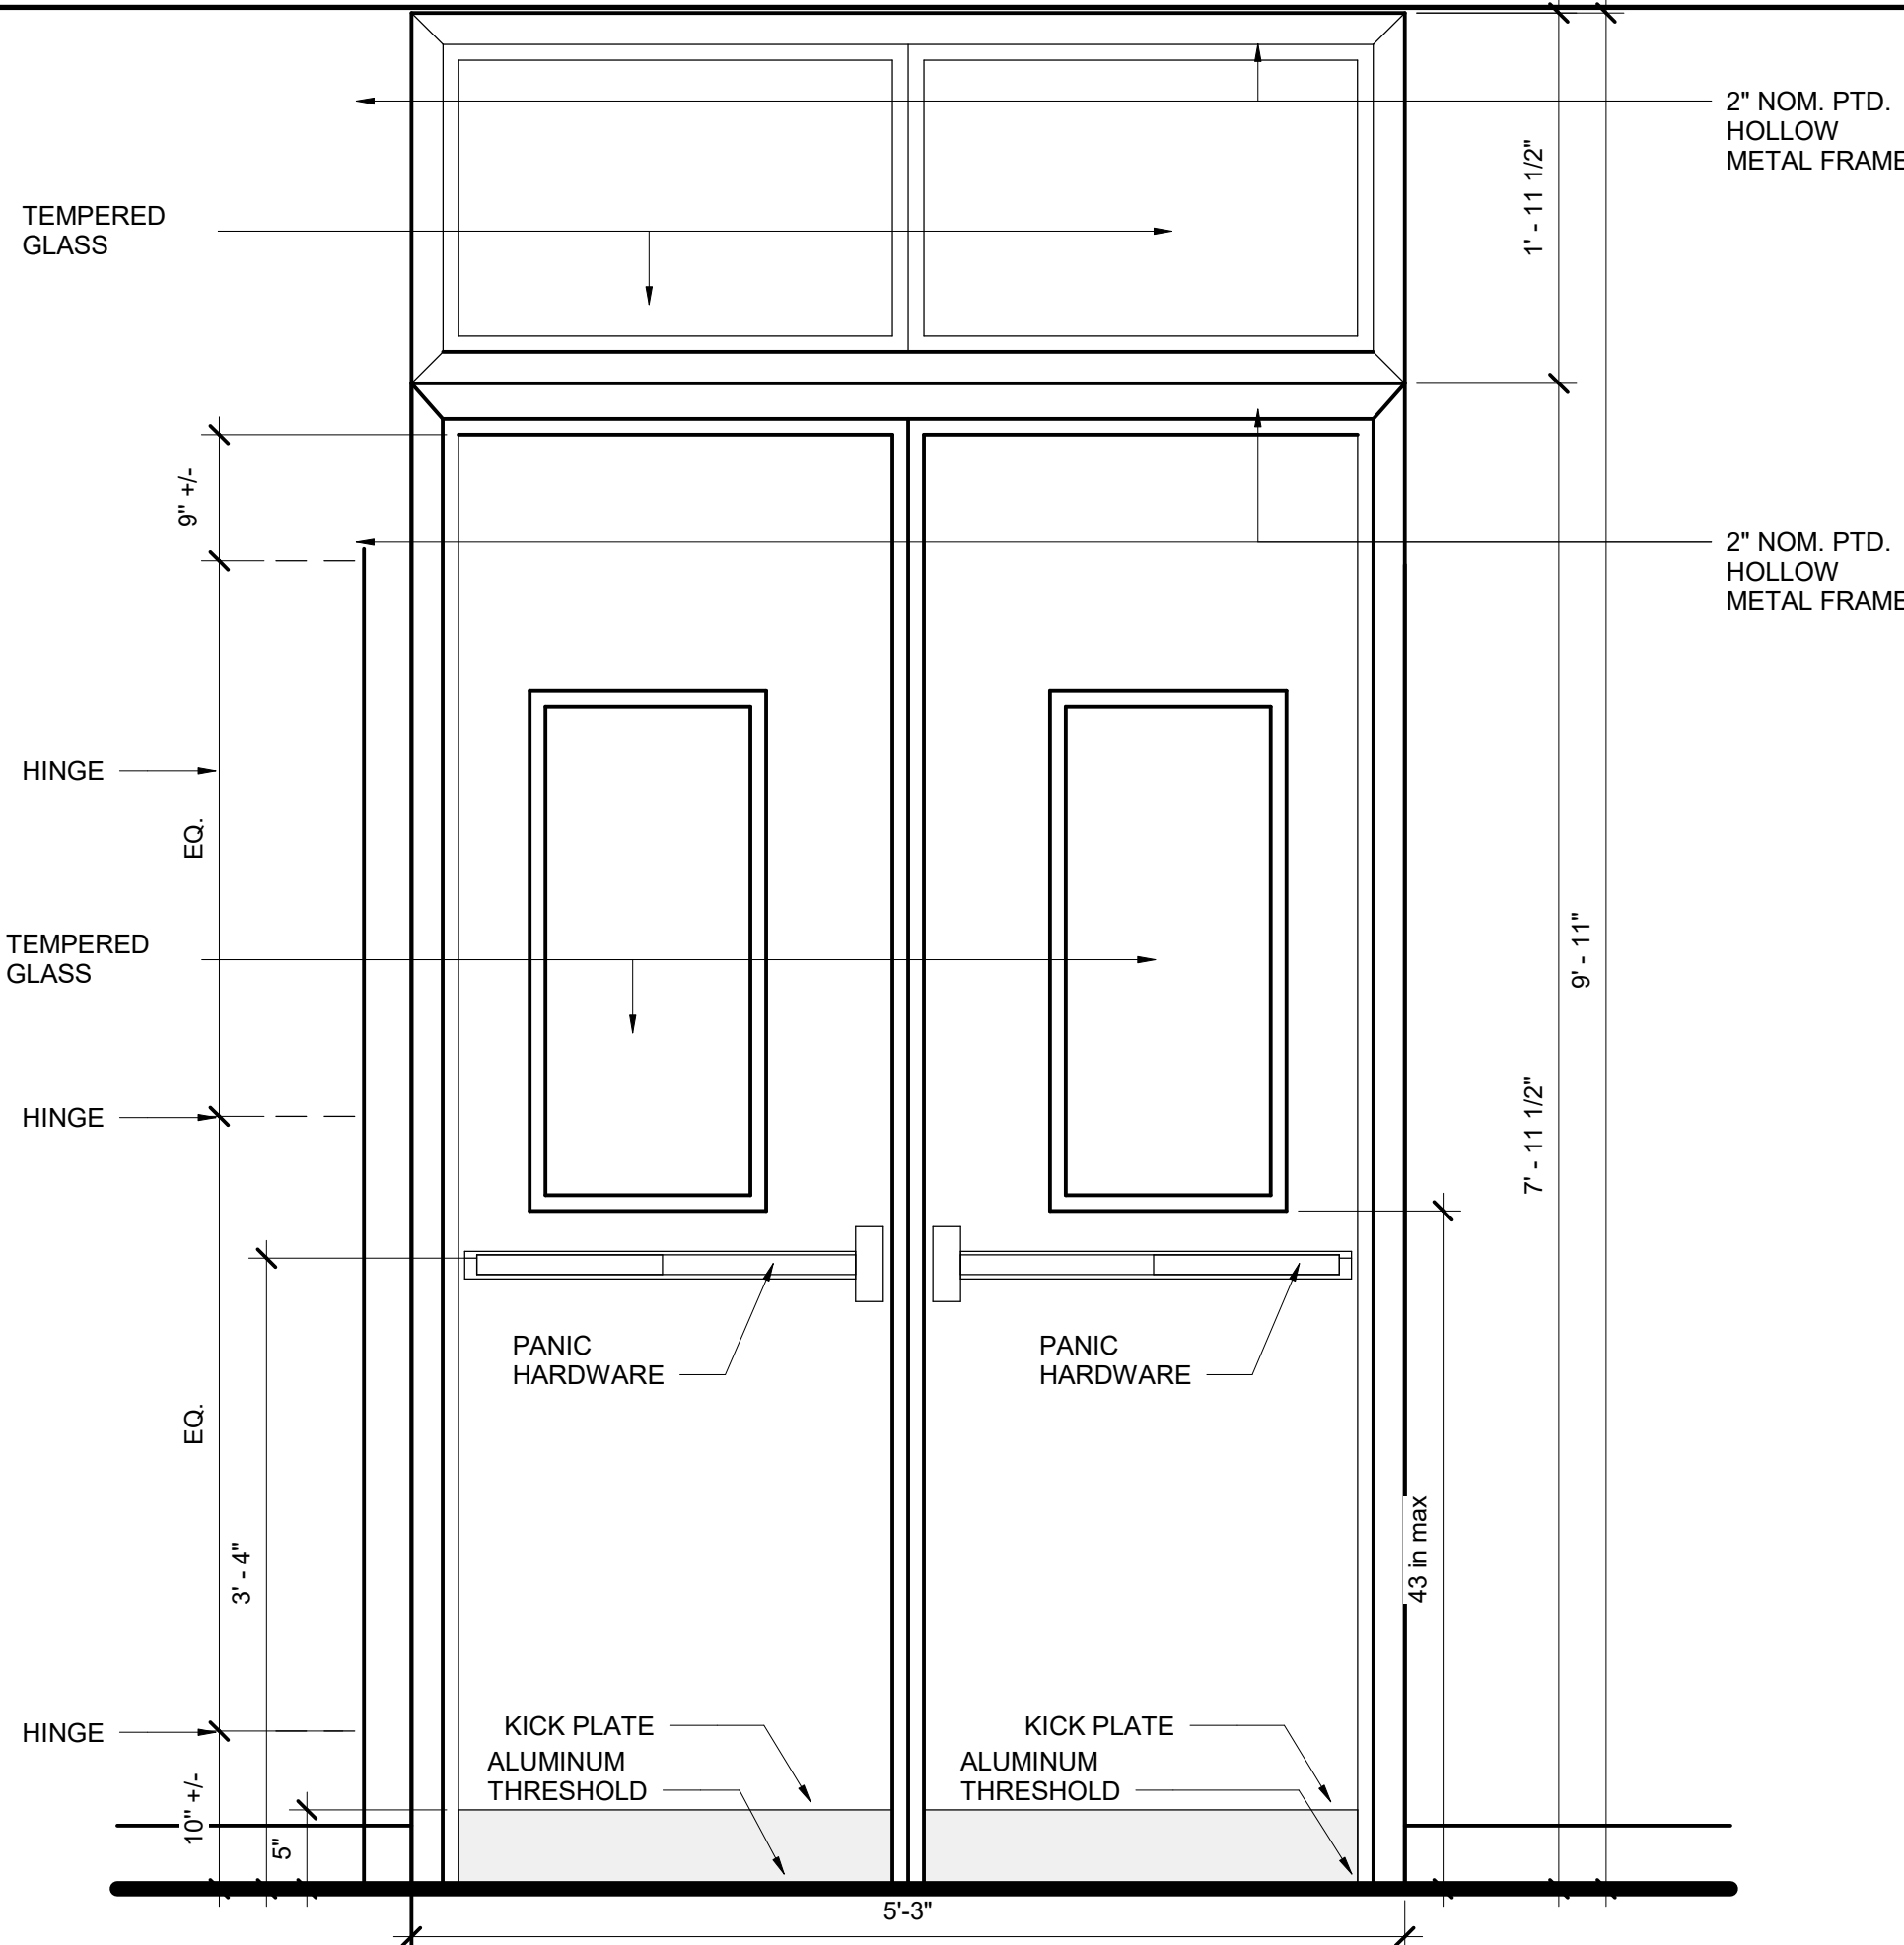


INSIDE THE BUILDING


DOOR HARDWARE SET 4

- GENERAL
- 1.DOOR HUNG TO THE FRAME WITH HINGES
 - 2.SECURITY LOCKSET
 - 3.THRESHOLD NEEDED
 - 4.SEALED AND PROTECTED DOOR (1HR RATED)
 - 5.ELECTRIFIED DOOR
 - 6.DOOR CLOSER
 - 7.DOOR MUST BE SEALED

- SPECIFIC CONSIDERATIONS
- 1. HEAVY FREQUENCY OF USE
 - 2. EXPOSED TO WEATHER/CLIMATE (ONLY FRONT DOOR)
 - 3. MATERIAL: TEMPERED GLASS AND ALUMINIUM

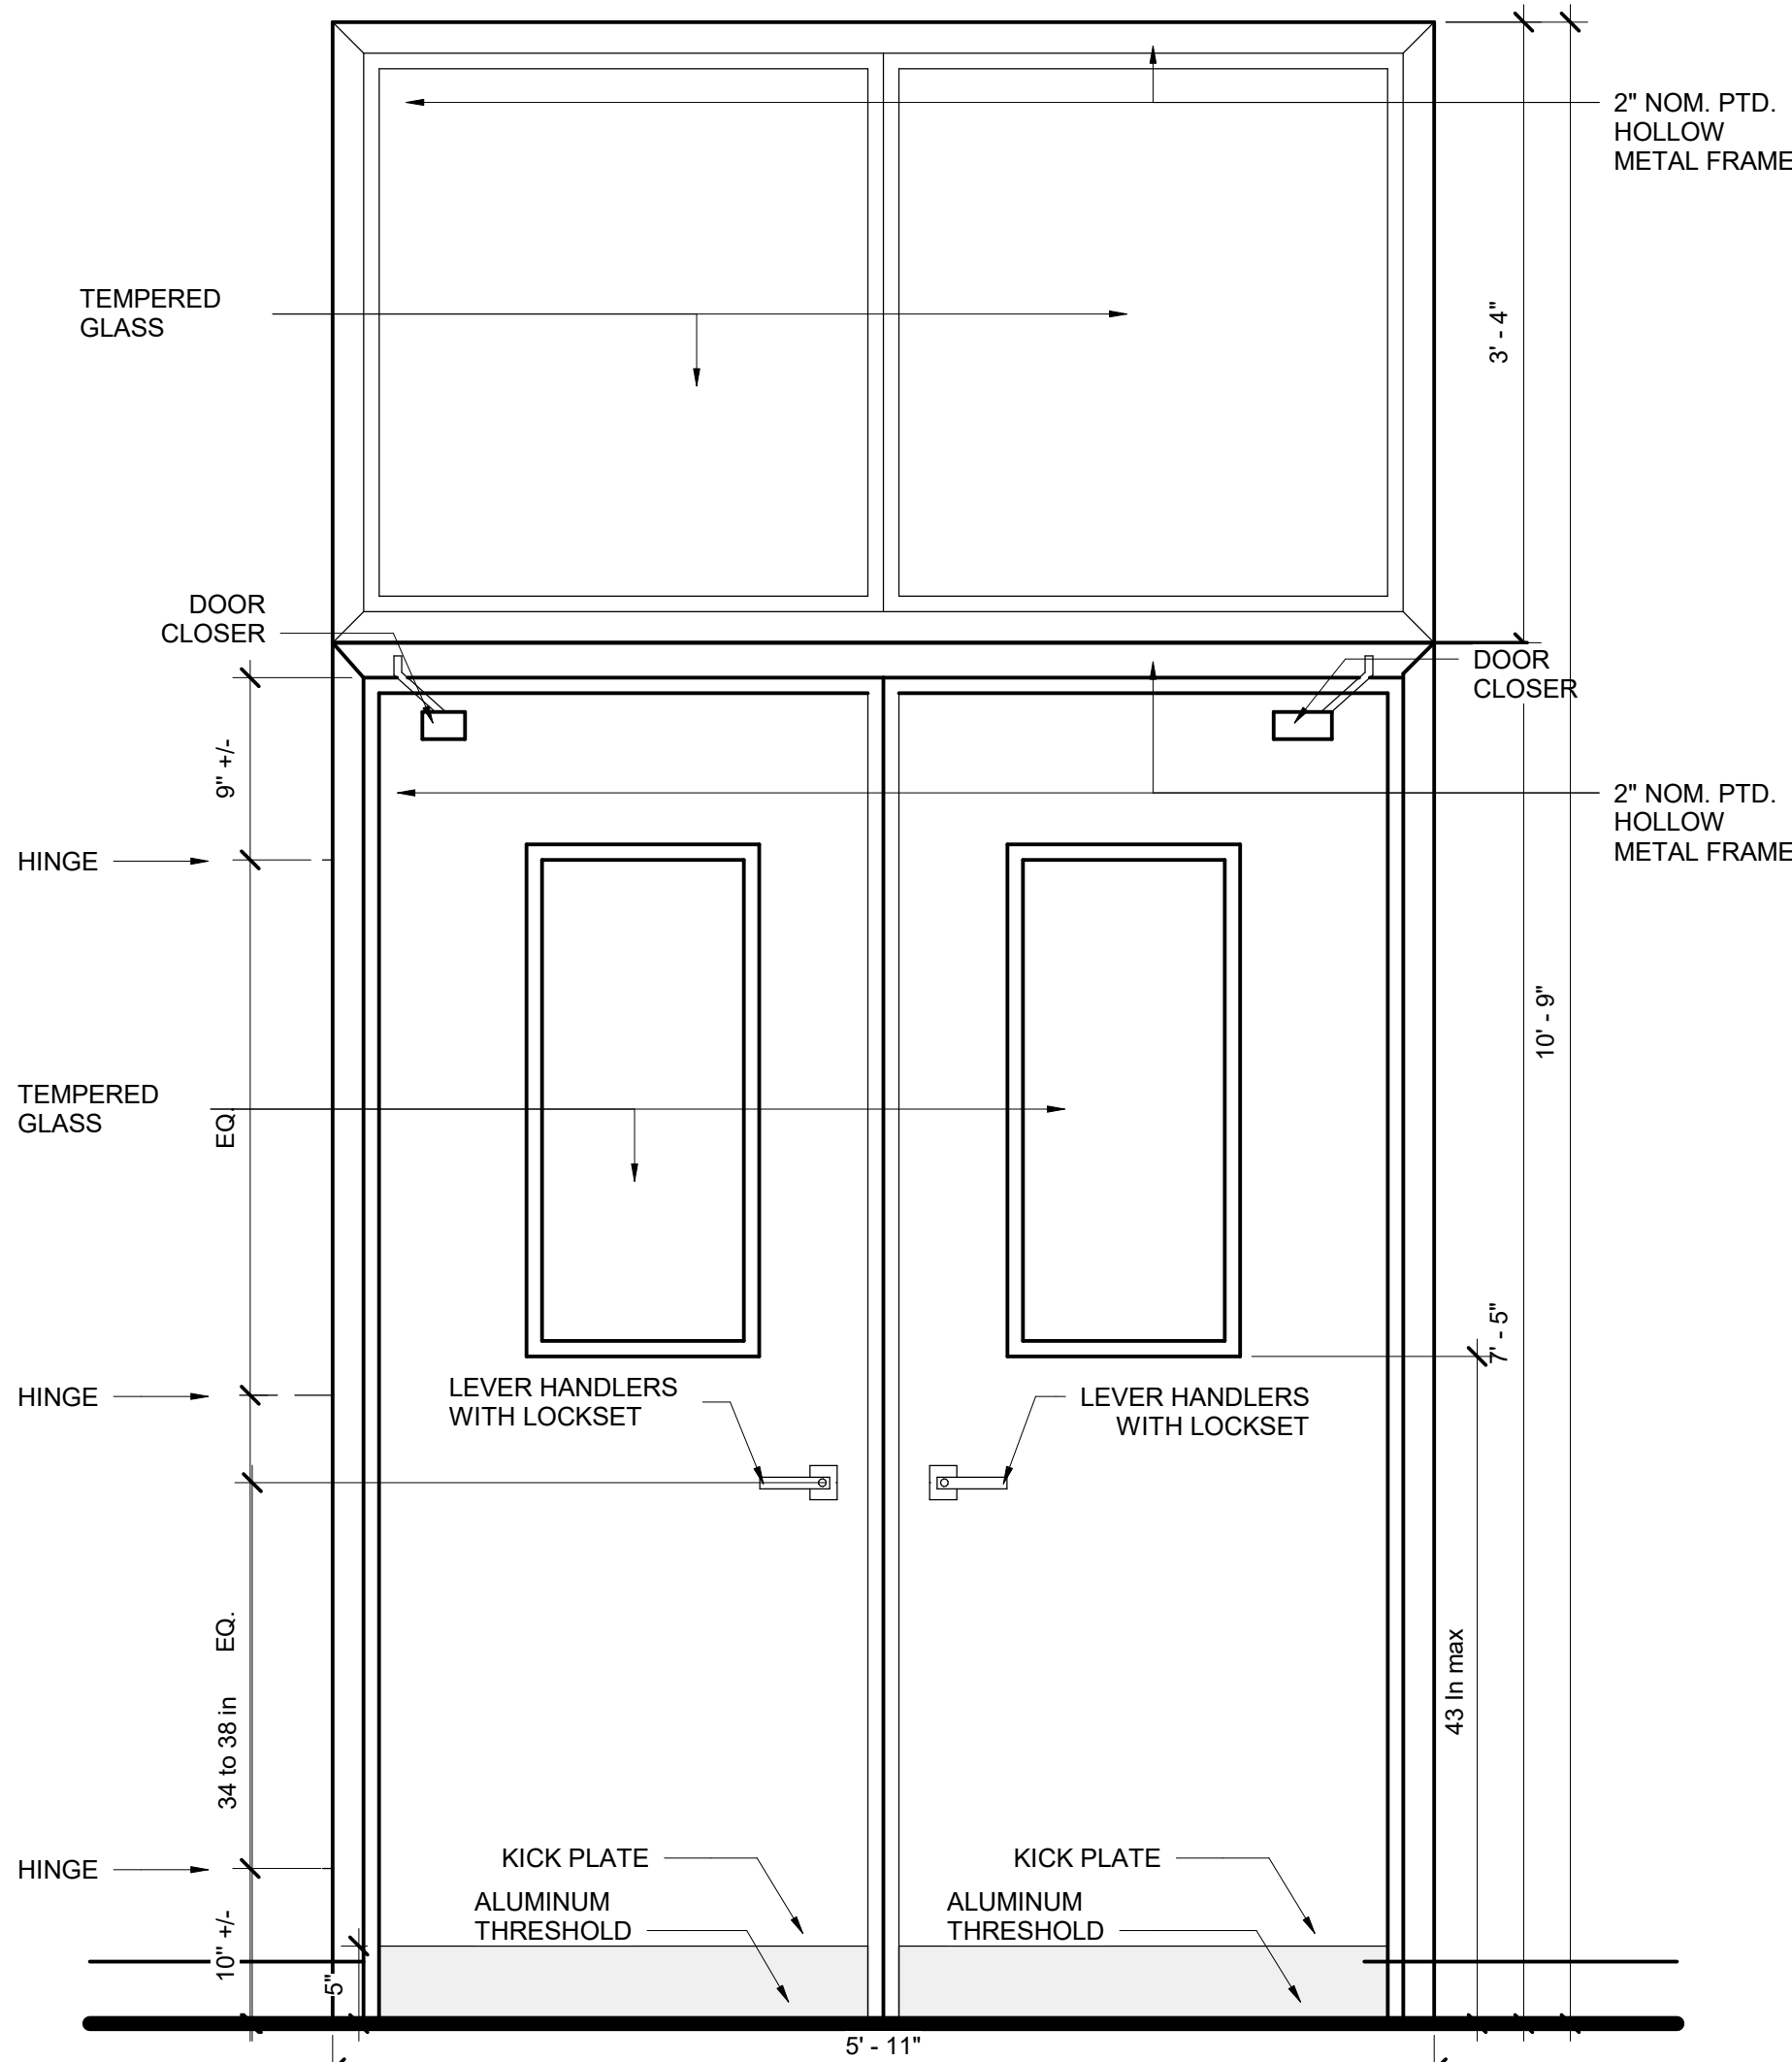

OUTSIDE THE BUILDING

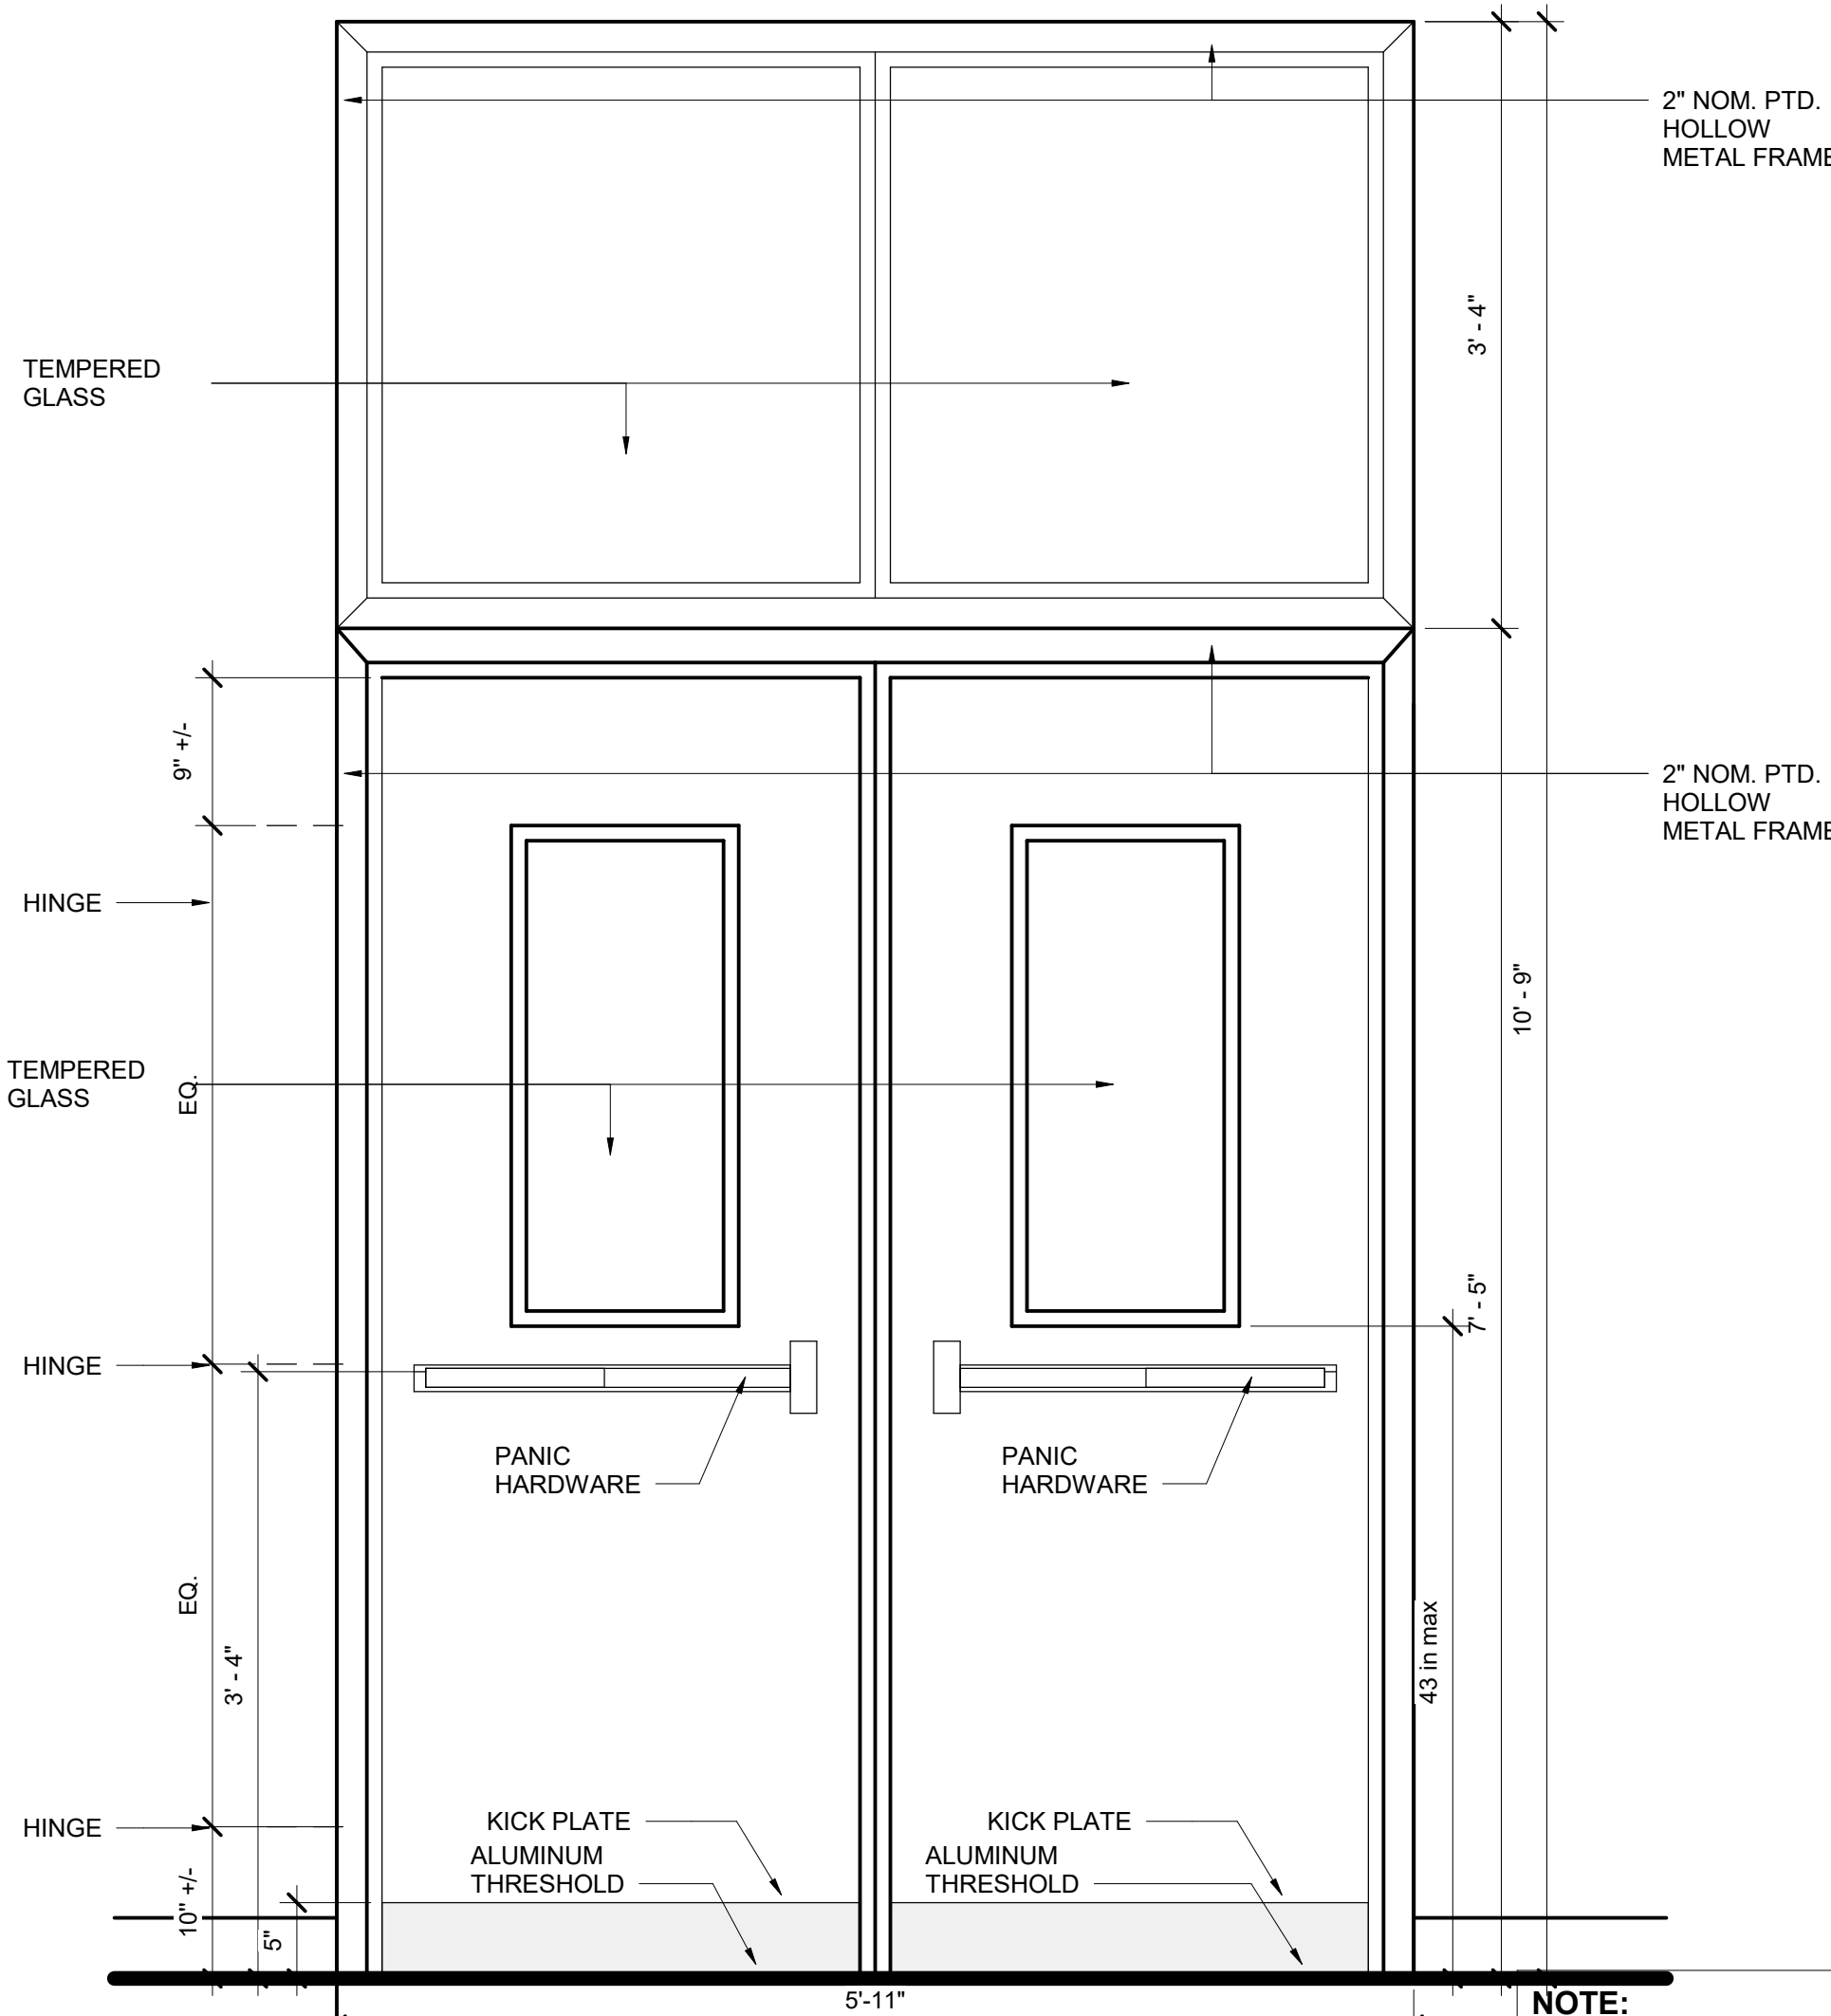

INSIDE THE BUILDING

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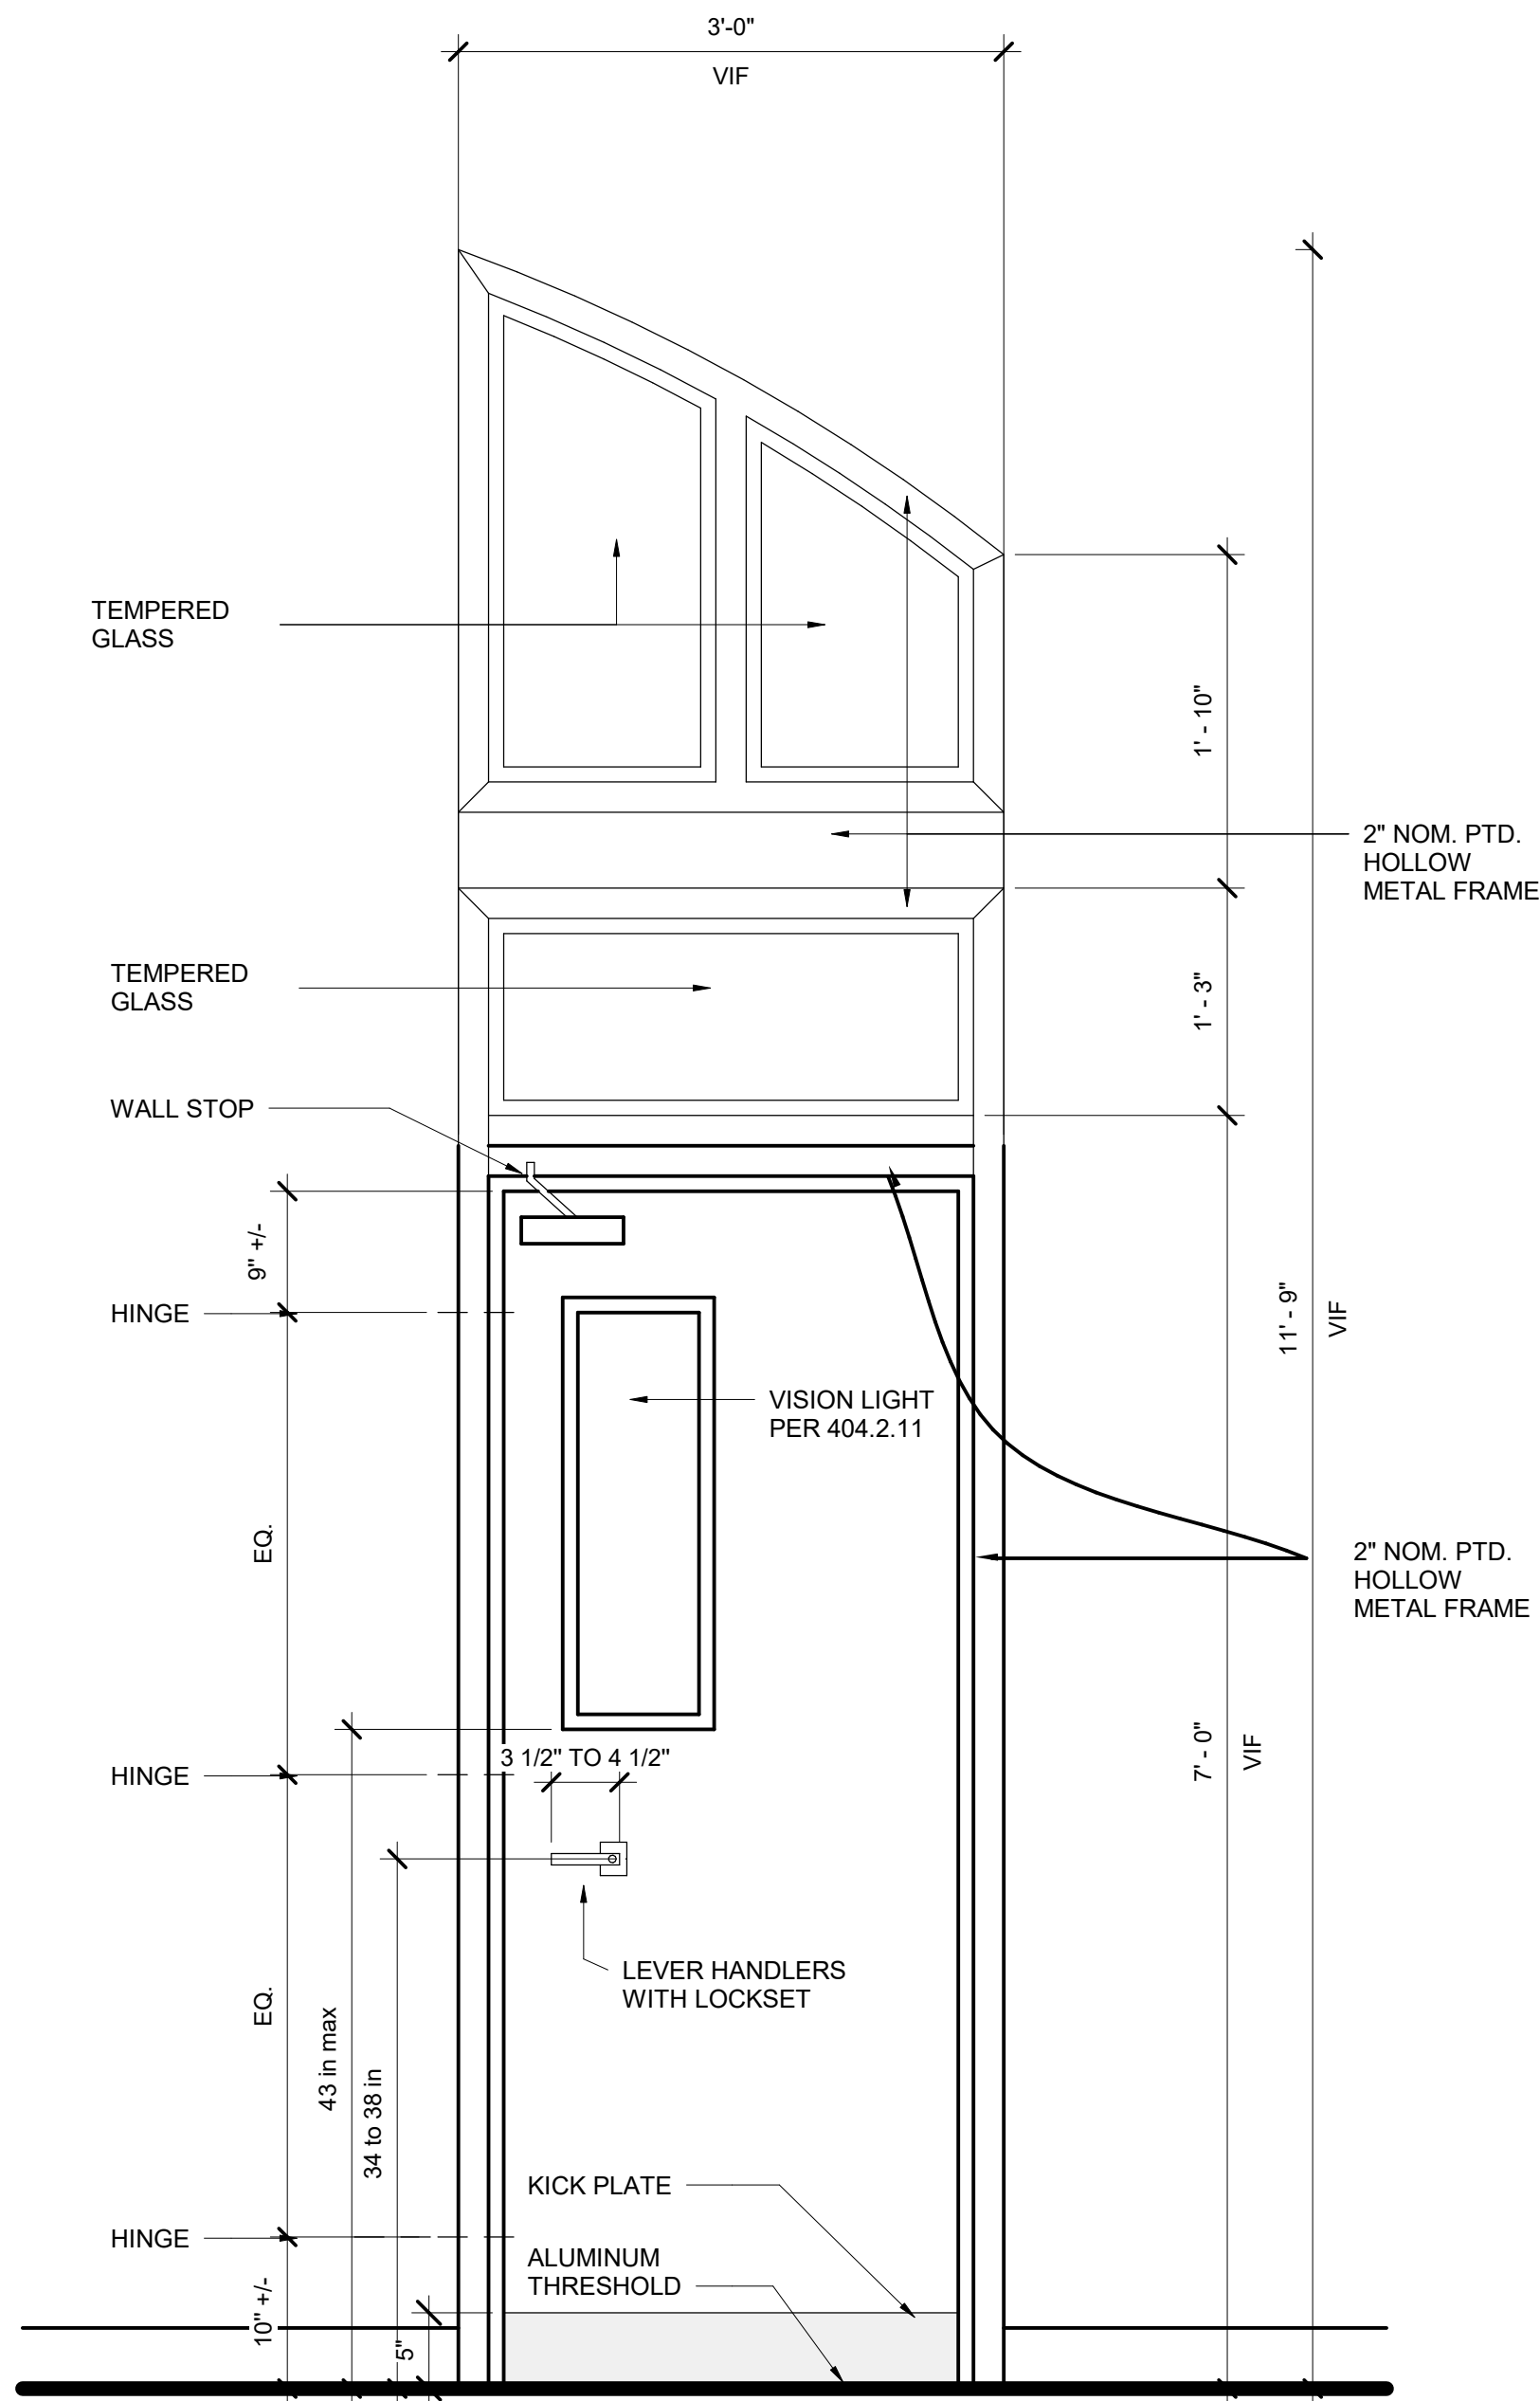
D102

Scale 1" = 1'-0"


DOOR HARDWARE SET 5

- GENERAL
- 1.DOOR HUNG TO THE FRAME WITH HINGES
 - 2.SECURITY LOCKSET
 - 3.THRESHOLD NEEDED
 - 4.SEALED AND PROTECTED DOOR (1HR RATED)
 - 5.NOT ELECTRIFIED DOOR
 - 6.DOOR CLOSER
 - 7.DOOR MUST BE SEALED

- SPECIFIC CONSIDERATIONS
- 1. HEAVY FREQUENCY OF USE
 - 2. EXPOSED TO WEATHER/CLIMATE (ONLY FRONT DOOR)
 - 3. MATERIAL: TEMPERED GLASS AND ALUMINIUM
 - 4. VERIFY DOOR SING DIRECTION ON EXISTING CONDITIONS PLAN



OUTSIDE THE BUILDING

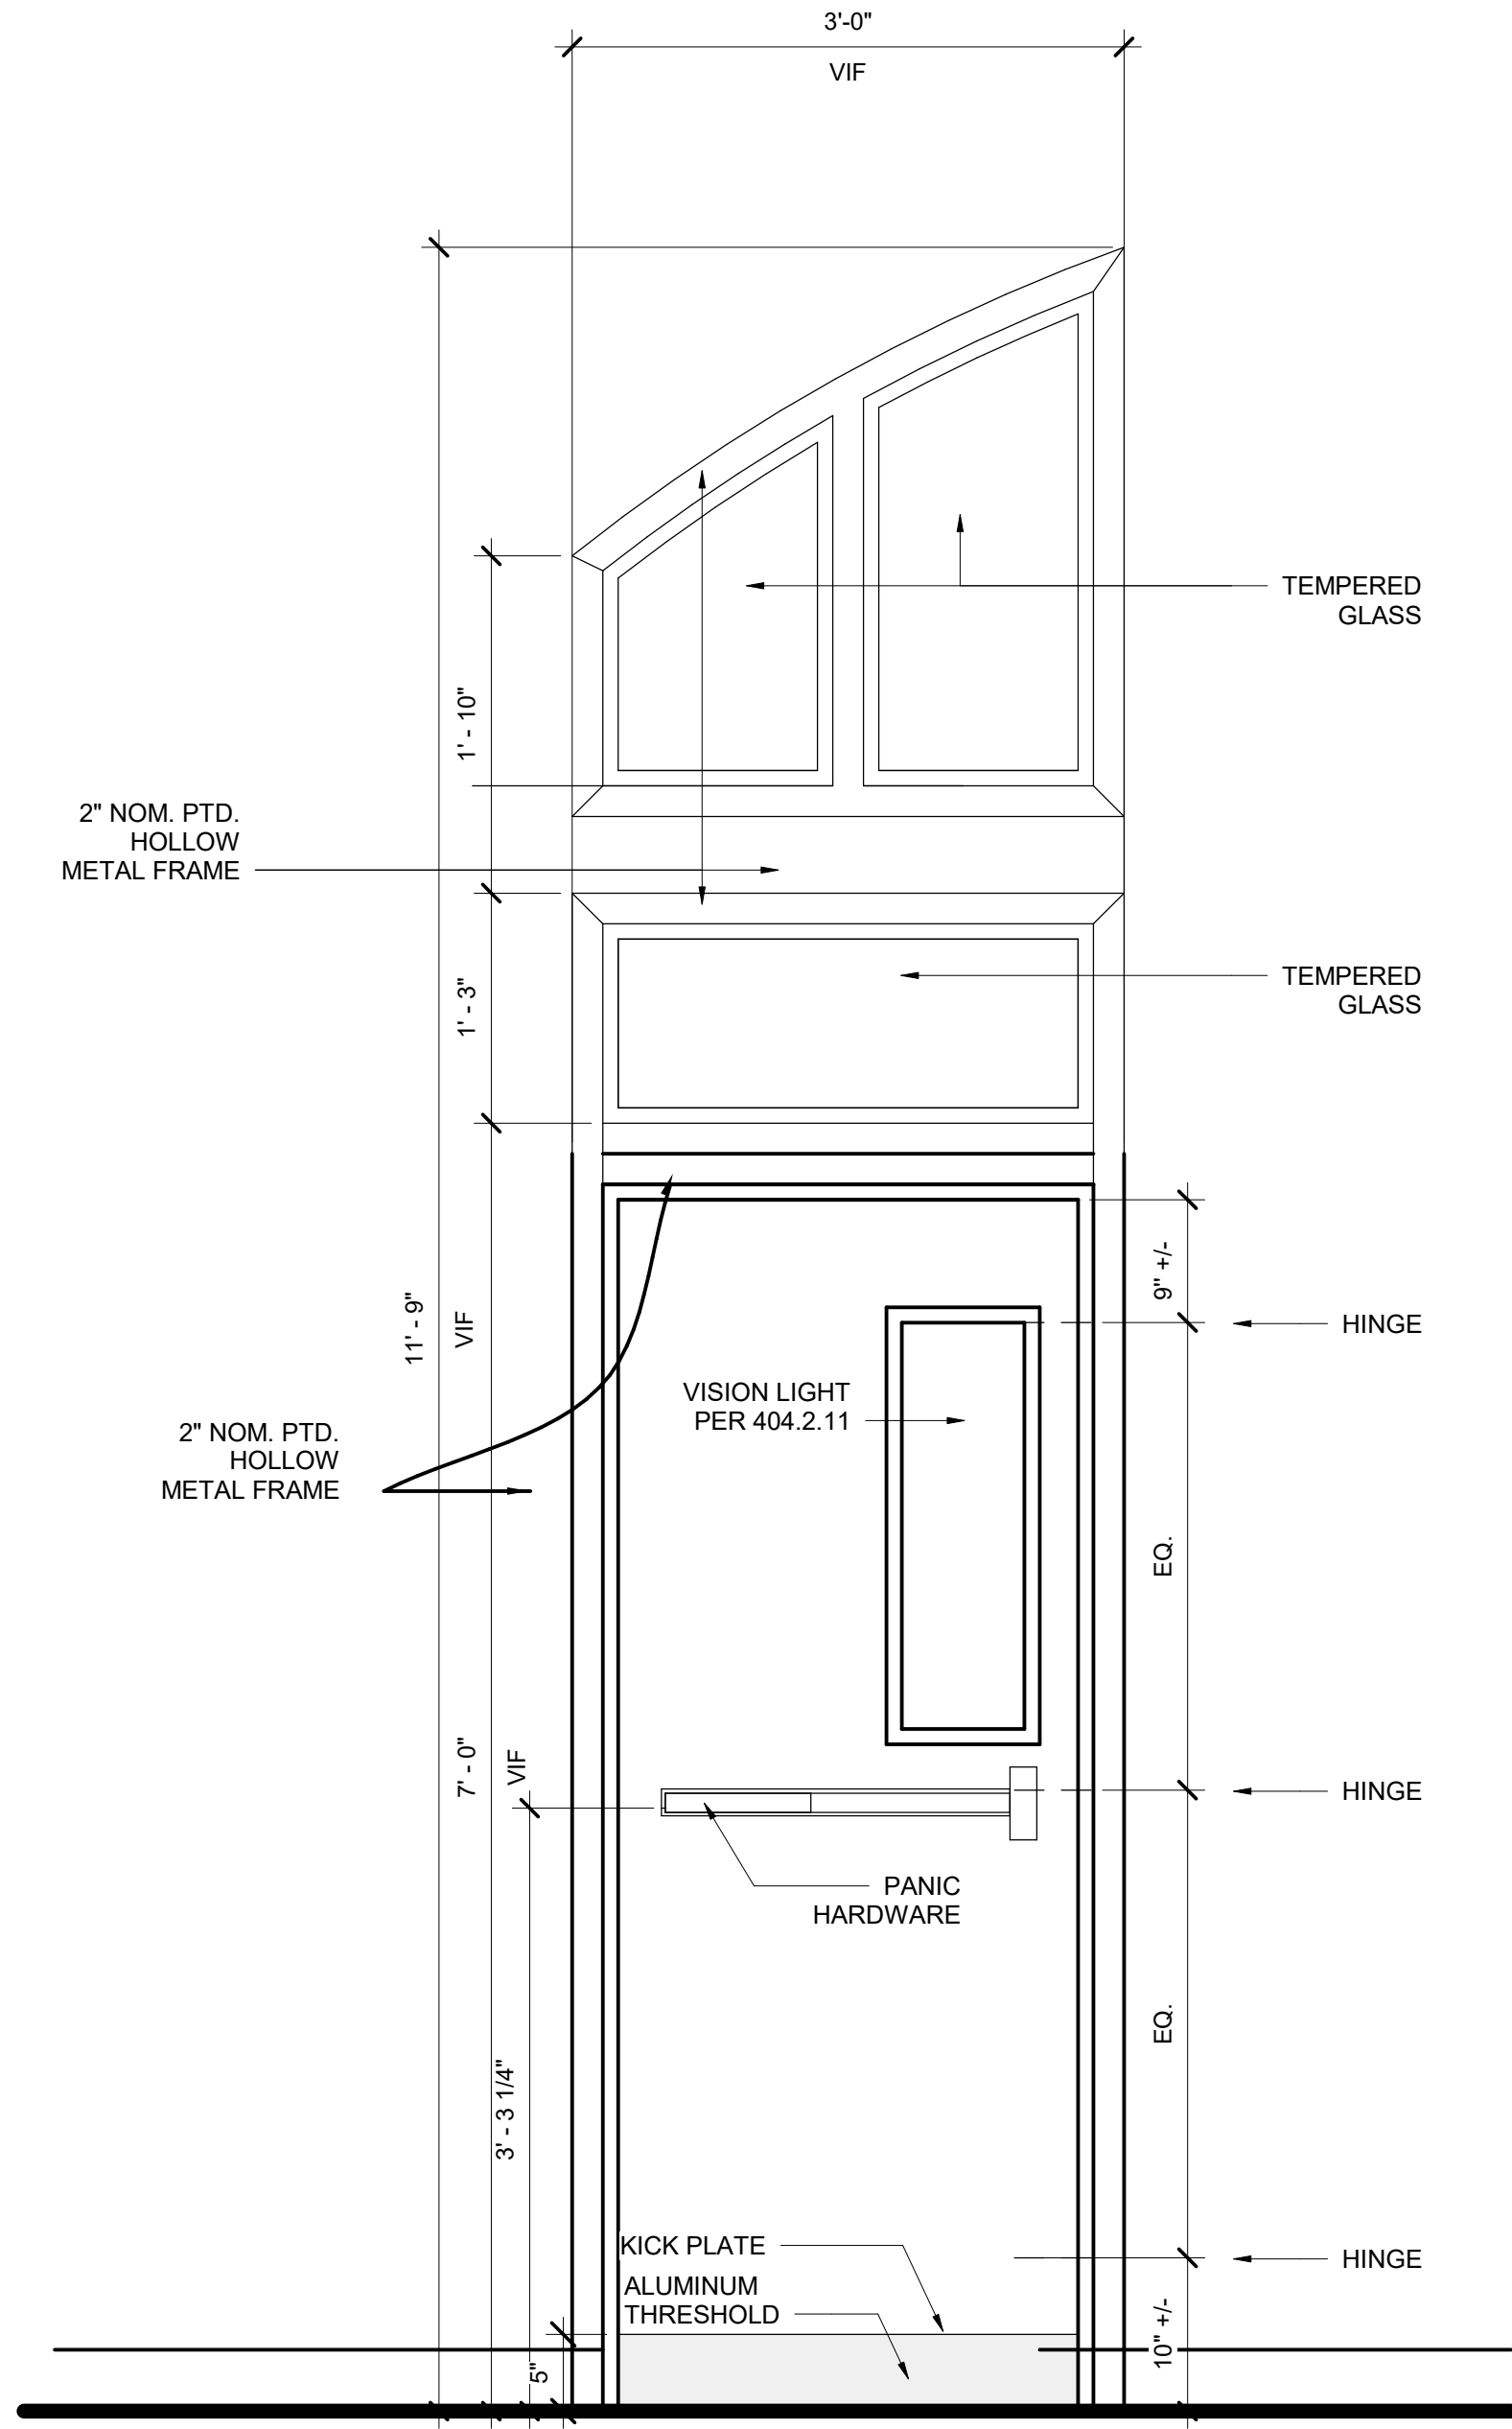

INSIDE THE BUILDING

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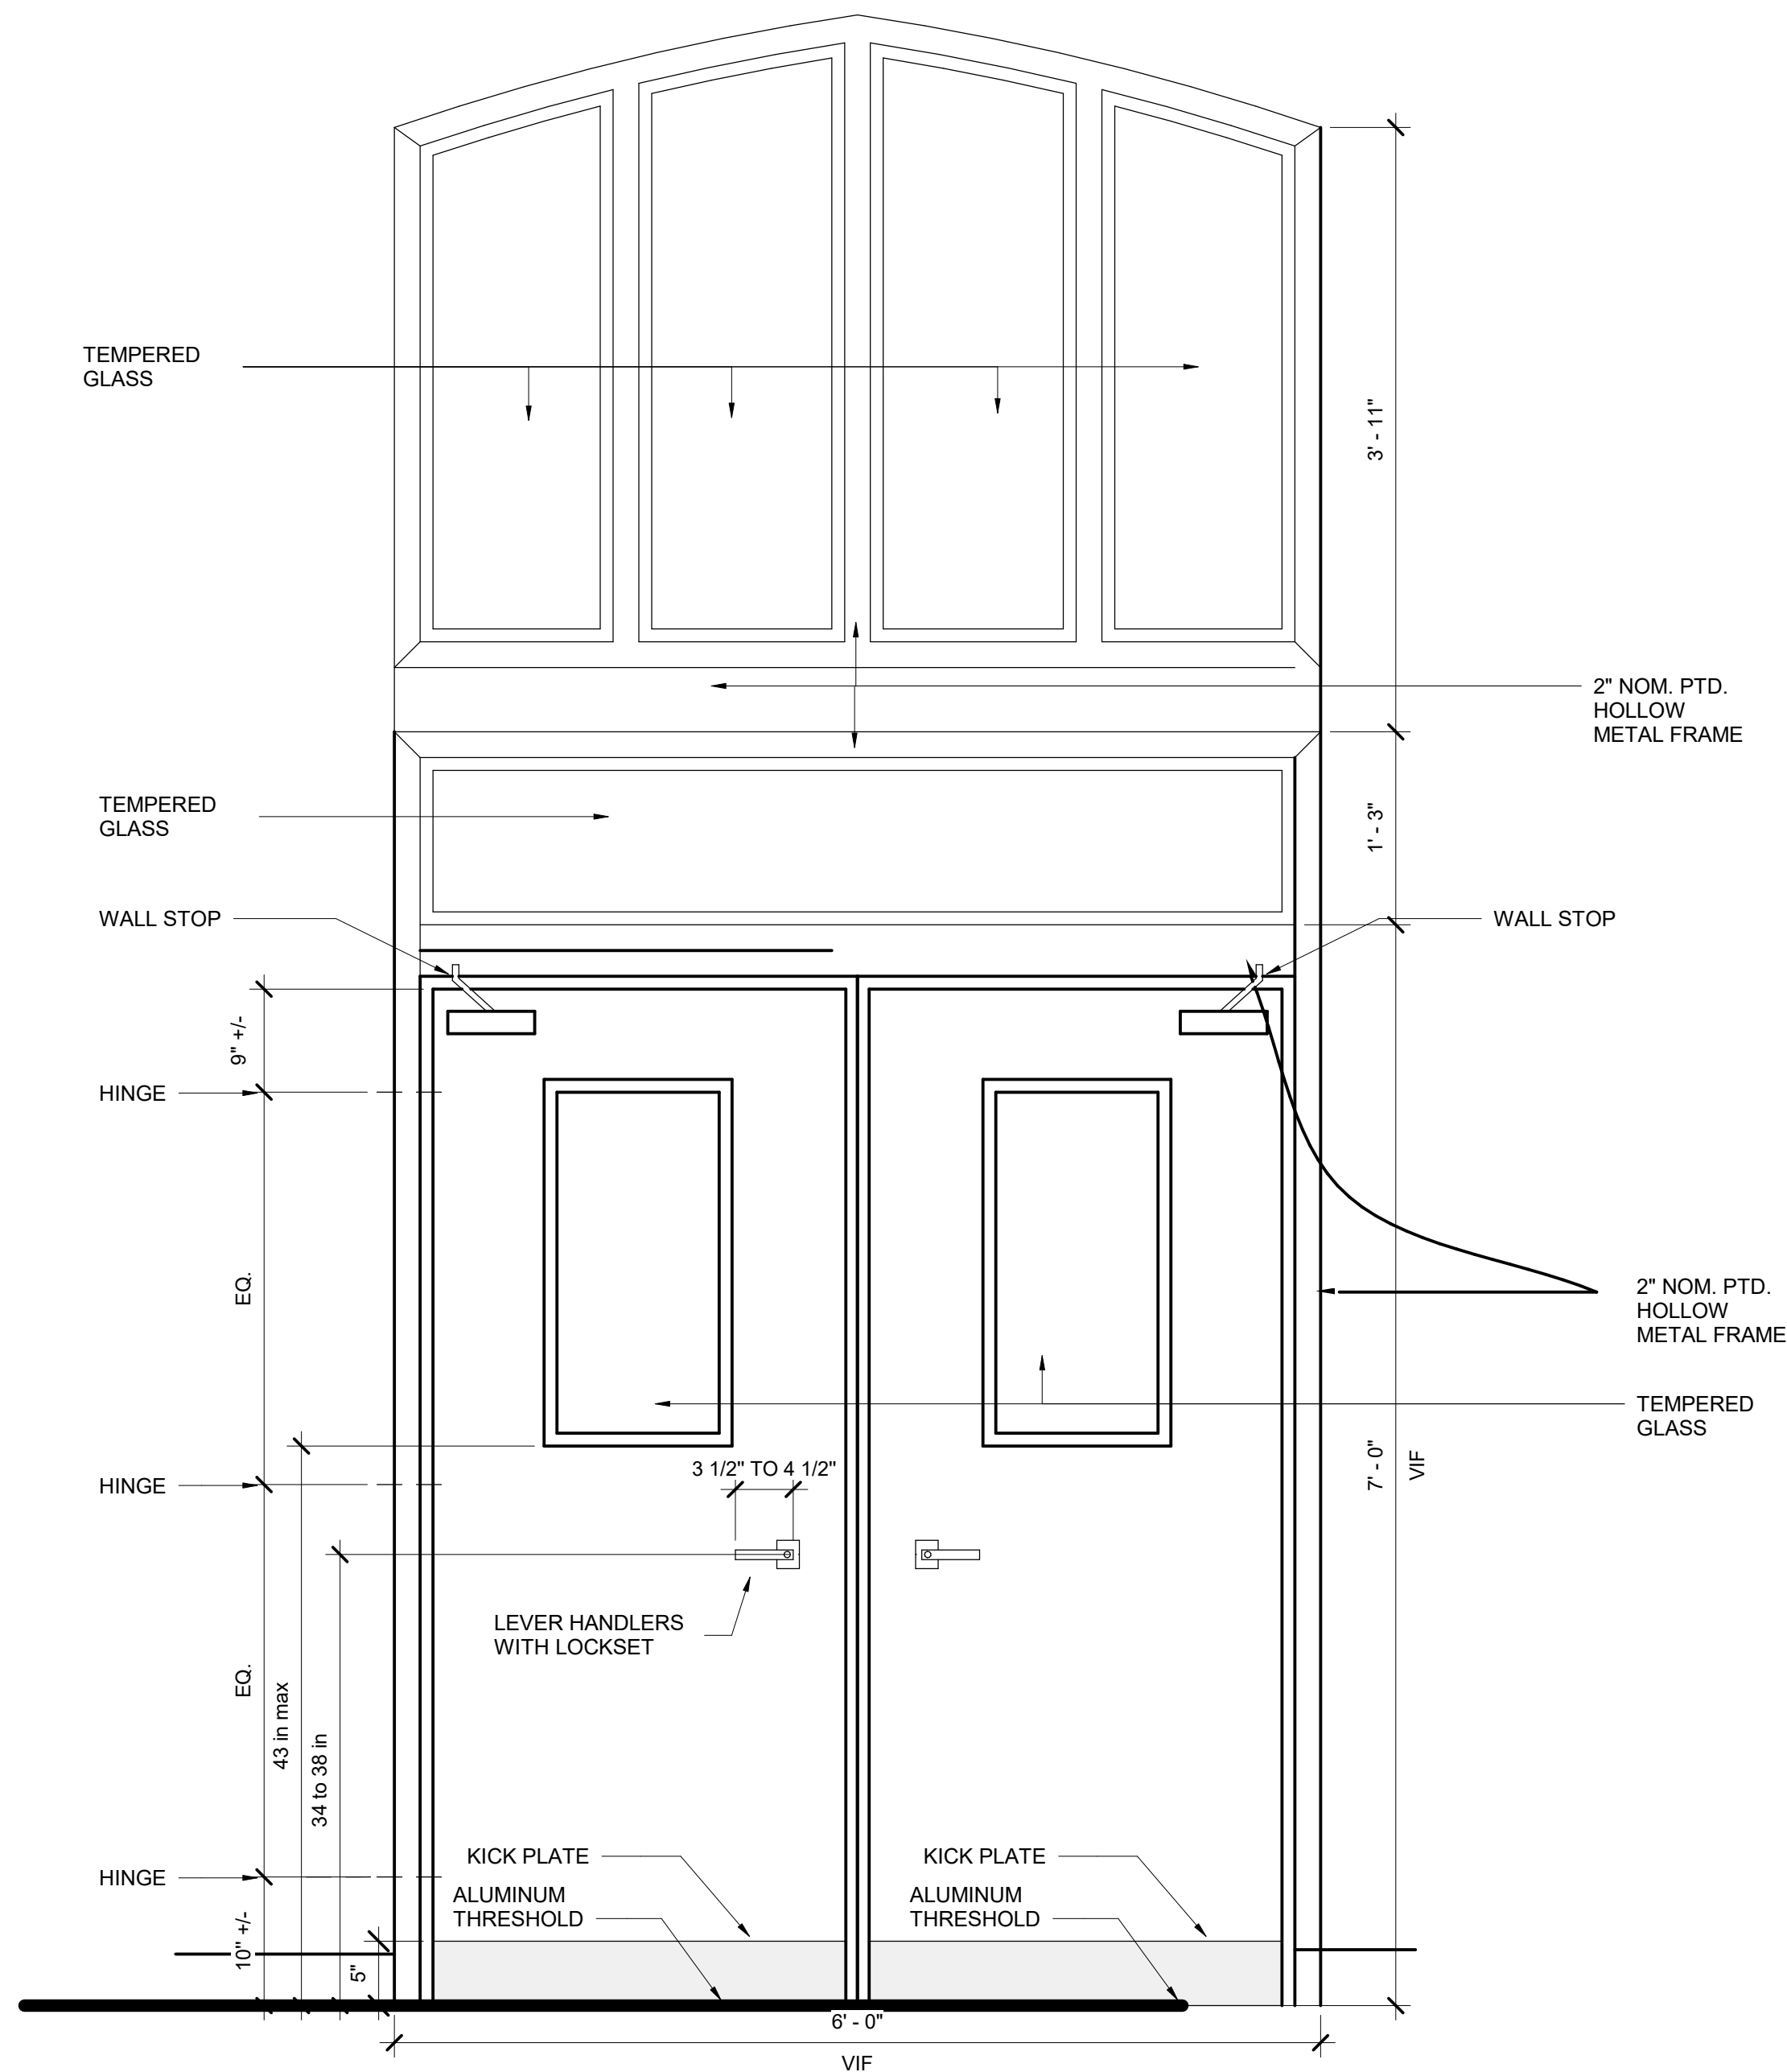
**DOOR HARDWARE
TYPES**

Project number	N/A
Date	10/04/2021
Drawn by	Author
Checked by	Checker
D103	
Scale	1" = 1'-0"


DOOR HARDWARE SET 6

- GENERAL
- 1.DOOR HUNG TO THE FRAME WITH HINGES
 - 2.SECURITY LOCKSET
 - 3.THRESHOLD NEEDED
 - 4.SEALED AND PROTECTED DOOR (1HR RATED)
 - 5. ELECTRIFIED DOOR
 - 6.DOOR CLOSER
 - 7.DOOR MUST BE SEALED

- SPECIFIC CONSIDERATIONS
- 1. HEAVY FREQUENCY OF USE
 - 2. EXPOSED TO WEATHER/CLIMATE (ONLY FRONT DOOR)
 - 3. MATERIAL: TEMPERED GLASS AND ALUMINIUM
 - 4. VERIFY DOOR SING DIRECTION ON EXISTING CONDITIONS PLAN




OUTSIDE THE BUILDING

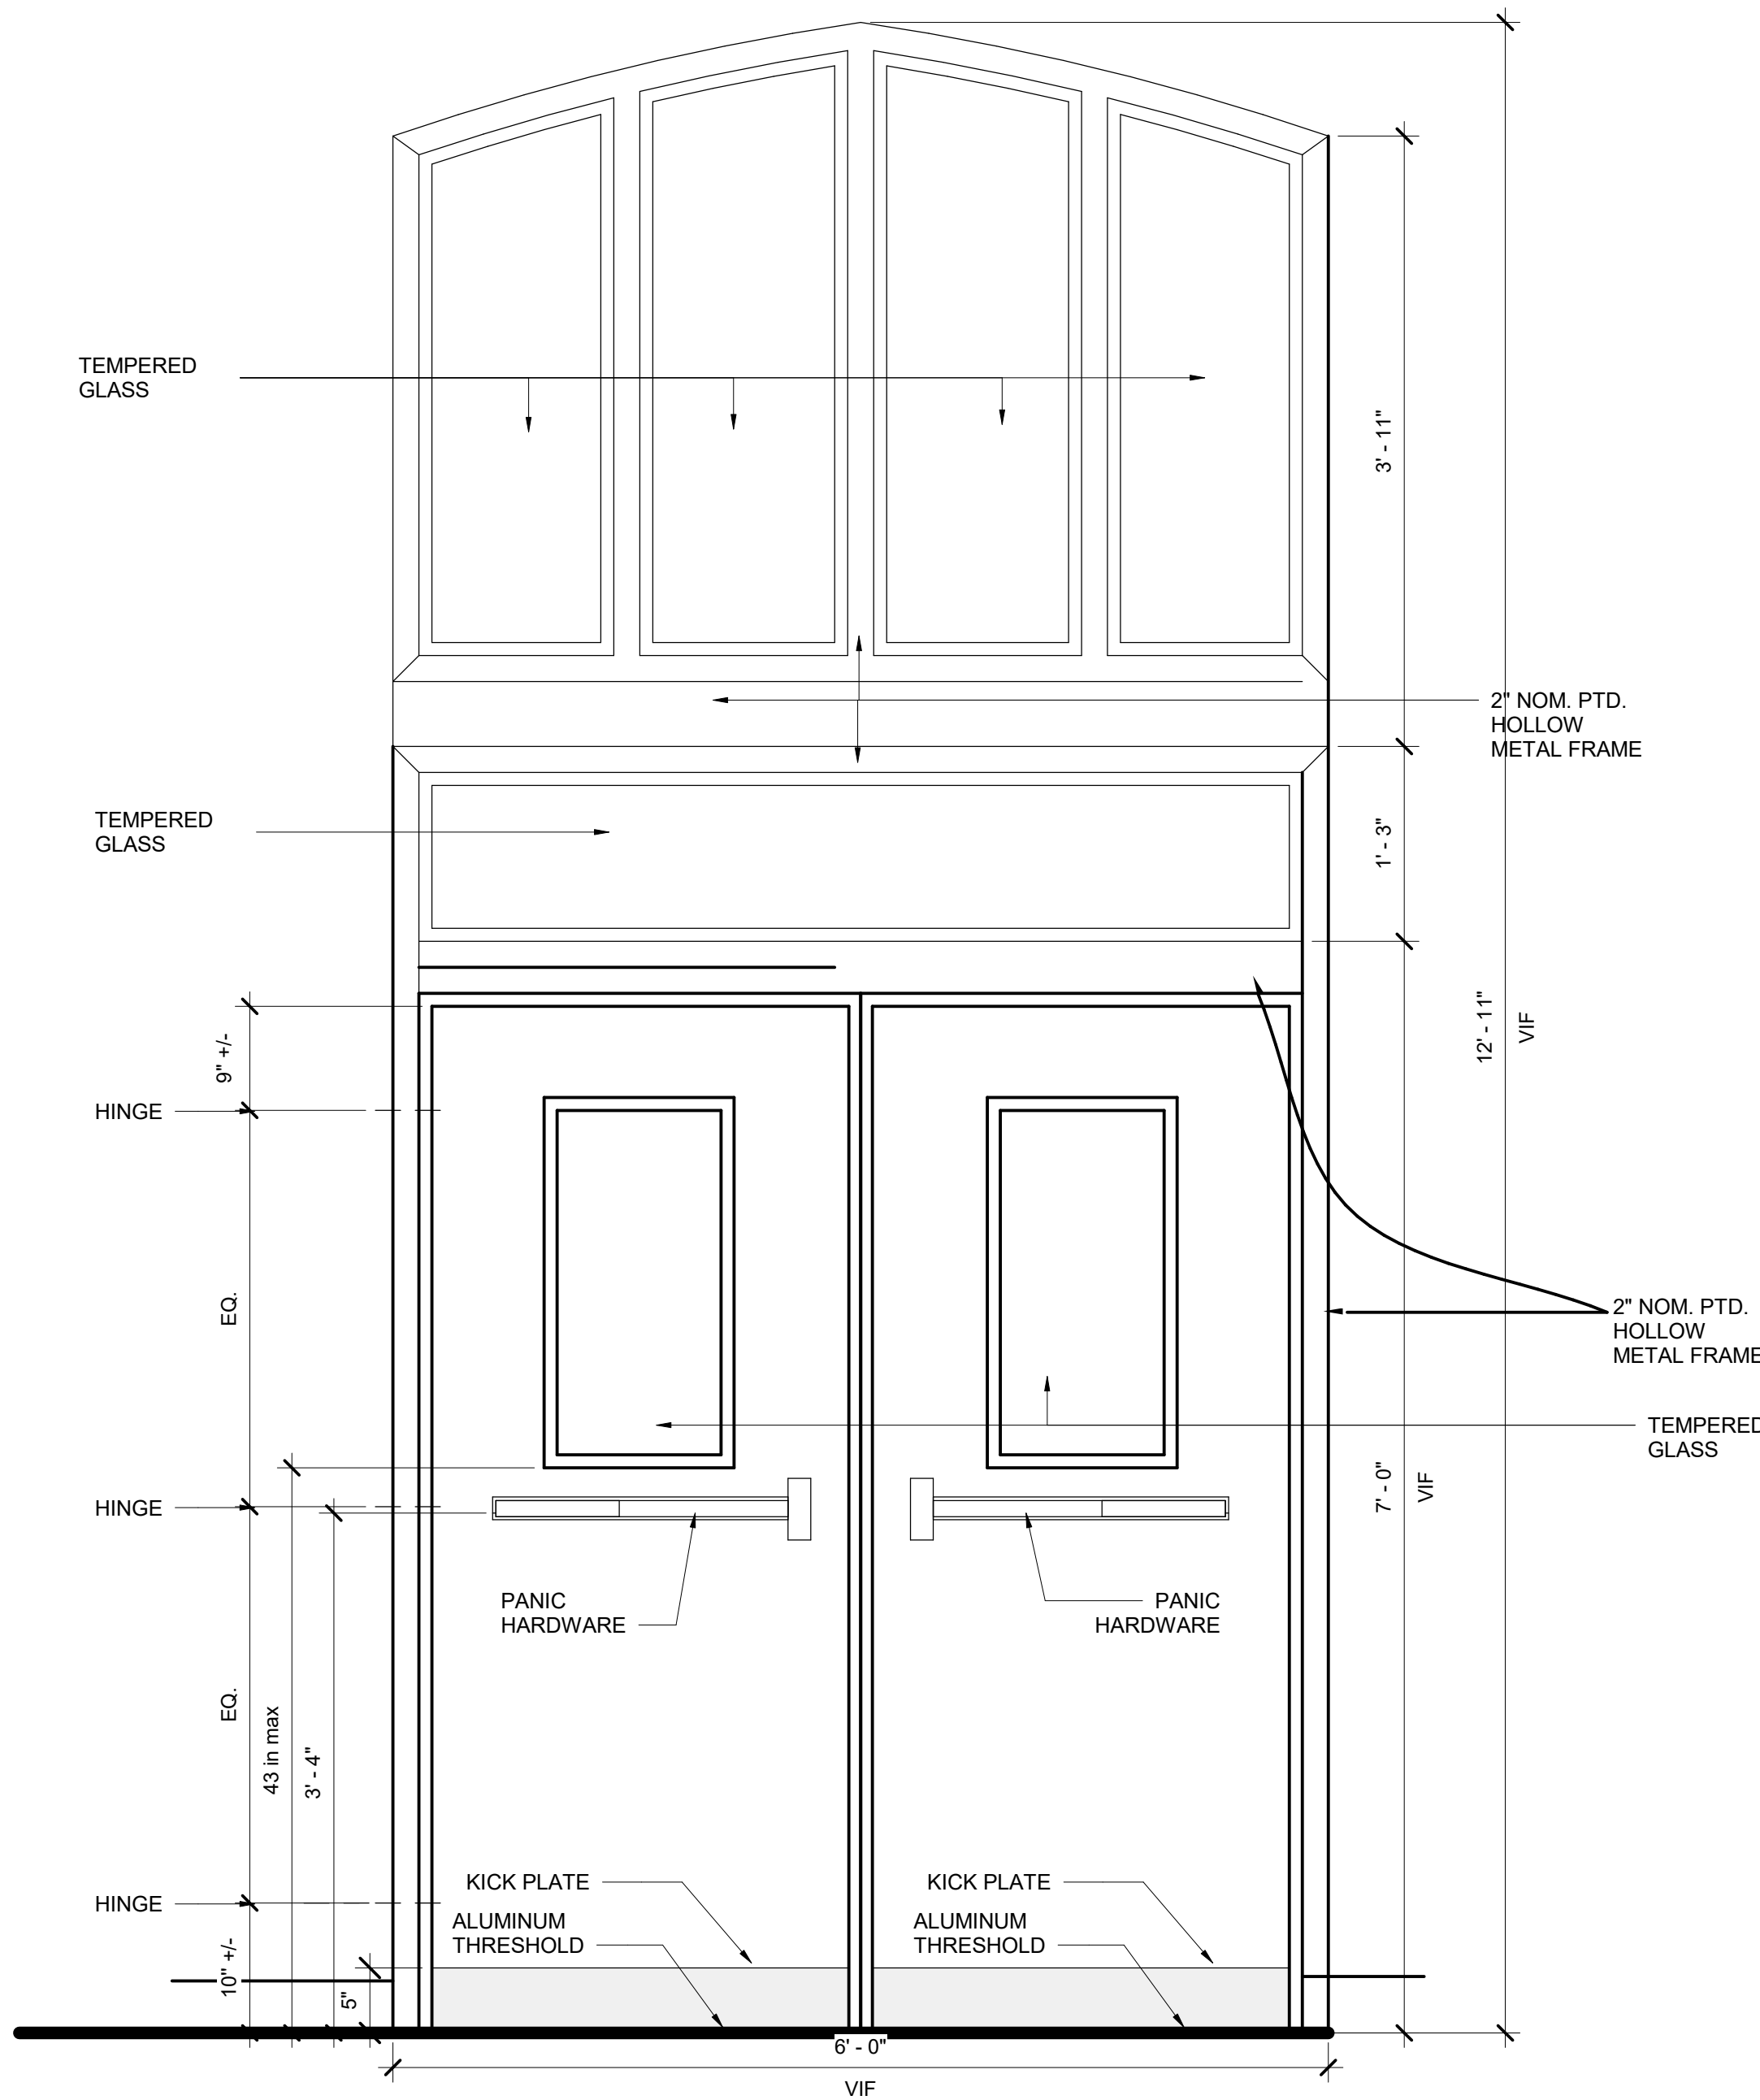

INSIDE THE BUILDING

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

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DOOR HARDWARE TYPES

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Date	10/04/2021
Drawn by	Author
Checked by	Checker

D104

Scale	1" = 1'-0"
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